# PROPOSED WAREHOUSE BUILDING FOR:

# CRAIGVILLE LOGISTICS



# 1220 CRAIGVILLE ROAD TOWN OF BLOOMING GROVE ORANGE COUNTY, NEW YORK

## INDEX

A-100 NOT

A-110 OVERALL FLOOR FIRST FLOOR PLAN

A-111 PARTIAL FLOOR PLAN

A-112 PARTIAL FLOOR PLAN

A-113 PARTIAL FLOOR PLAN

A-120 OVERALL MEZZANINE PLAN

A-130 OVERALL ROOF PLAN

A-201 FRONT ELEVATION

A-202 LEFT AND RIGHT ELEVATION

A-203 REAR ELEVATION

A-211 FRONT ELEVATION DETAILS

A-212 FRONT ELEVATION DETAILS

A-213 RIGHT AND LEFT ELEVATION DETAILS

A-214 BACK ELEVATION DETAILS

A-301 TYP. WALL SECTION

A-302 DETAILS AND NOTES

A-303 DETAILS

A-401 DIMENSION FOR PANELS

## RELEASE DATE:

8-18-2022

8-18-2022 Released for permit 12-22-2022 Revised to smaller foot print 10-26-2023 Revised as per B.D.

1-29-2024 Revised as per P.B.



412 N. MAIN STREET. SUITE 301 MONROE NY 10950 845-781-4222 LARRY@LHARTMANDESIGN.COM

# PROJECT INFORMATION

# CODE ANALYSIS

#### PROJECT ARCHITECT:

HARTMAN DESIGN 412 N. MAIN STREET 845-781-4222 LARRY@LHARTMANDESIGN.COM — SHMUEL@LHARTMANDESIGN.COM

#### PROJECT OWNER: KEY DEVELOPERS NY INC.

718-687-4247 EXT 230 845-304-8767 JJ@KEYDEVELOPERSNY.COM MANNYG@KEYDEVELOPERSNY.COM

#### PROJECT CONTRACTOR:

INDIGO BUILDERS 845.237.9999 EXT. 101 845.637.1152 BUILTBYINDIGO@GMAIL.COM

#### PROJECT PLANNER:

ESPOSITO AND ASSOCIATES 262 GREENWICH AVE SUITE B GOSHEN NY 10924 EANDA@ESPOSITOANDASSOCIATES.NET

#### PROJECT CIVIL ENGINEER:

ARDEN CONSULTING ENGINEERS, P.O.B. 340 MONROE, N.Y. 10949 T: 845-782-8114 MAM@ARDENCONSULTING.NET

#### PROJECT ENVIRONMENTAL COSULTING

B. LAING ASSOCIATES \_\_\_\_\_ -----

----

#### PROJECT GEOTECHNICAL ENGINEER:

---------KEVIN@PATTONGEOTECH.COM

#### PROJECT TRAFFIC CONSULTANT:

CREIGHTON MANNING --------

#### PROJECT WETLAND CONSULTANT:

MIKE NOWICKI \_\_\_\_\_ -----

### PROJECT STRUCTURAL ENGINEER:

LJB ENGINEERING -------------

#### PROJECT MEP ENGINEER:

--------

MP ASSOCIATES

### STEEL FABRICATORS:

MCCOMBS STEEL COMPANY, INC. 117 SLINGSHOT RD. STATESVILLE, NC. 28677 704-902-3742 C 704-873-7563 EXT 207 WWW.MCCOMBS-STEEL.COM JPAYNE@MCCOMBS-STEEL.COM

## TILT-UP CONCRETE:

SULLIVAN CONTRACTORS \_\_\_\_\_ -----

----

#### APPLICABLE NYS CODES:

2020 BUILDING CODE OF NEW YORK STATE (BCNYS) 2020 ENERGY CONSERVATION CODE OF NEW YORK STATE (ECCCNYS) 2020 NYS PLUMBING CODE, MECHANICAL CODE, FIRE CODE AND FUEL GAS CODE

#### **CLASSIFICATION OF WORK:** NEW CONSTRUCTION

CHAPTER 3-BUILDING DATA GROUP S-1 STORAGE

GROUP B BUSINESS

## CHAPTER 5

#### TABLE 504.3 ALLOWABLE BUILDING HEIGHT IN FEET ABOVE GRADE PLANE TYPE OF MAX ACTUAL

OCCUPANCY	SPRINKLER	CONSTRUCTION	MAX. HEIGHT	HEIGHT
GROUP S-1	YES	TYPE II-B	75'	46'-8"
GROUP B	YES	TYPE II-B	75'	46'-8"

#### TABLE 504.4 ALLOWABLE NUMBER OF STORIES ABOVE GRADE PLANE

OCCUPANCY	SPRINKLER	TYPE OF CONSTRUCTION	MAX. STORIES	ACTUAL STORIES	COMMENTS
GROUP S-1	YES	TYPE II-B	3	1	SEE SECTION 505.2
GROUP B	YES	TYPE II-B	4	1	SEE SECTION 303.2

SECTION 505.2 MEZZANINES ARE LESS THAN A THIRD OF THE FLOOR AREA OF THAT ROOM IN WHICH THEY ARE LOCATED AND SHALL BE CONSIDERED A PORTION OF THE STORY BELOW. SUCH MEZZANINES SHALL NOT CONTRIBUTE TO EITHER THE BUILDING AREA OR NUMBER OF STORIES.

SECTION 505.2.3 MEZZANINES HAVE TWO EXITS AND ARE NOT REQUIRED TO BE OPEN TO THE ROOM IN WHICH THEY ARE LOCATED.

#### TABLE 506.2 ALLOWABLE AREA IN SQUARE FEET

OCCUPANCY	SPRINKLER	TYPE OF CONSTRUCTION	MAX. AREA	ACTUAL AREA	COMMENTS
GROUP S1	YES	TYPE II-B	78,000	562,450	SEE SECTION 505.2
GROUP B	YES	TYPE II-B	69,000	562,450	SEE SECTION 507.4

SECTION 507.4 GROUP B AND S BUILDING SHALL NOT BE LIMITED WHERE THE BUILDING IS PROVIDED WITH AN AUTOMATIC SPRINKLER SYSTEM AND IS SURROUNDED AND ADJOINED BY PUBLIC WAYS OR YARDS NOT LESS THAN 60 FEET

NO FIRE SEPARATION REQUIRED BETWEEN GROUP S-1 AND B

TABLE 508.4 REQUIRED SEPARATION OF OCCUPANCIES

#### CHAPTER 6 TYPES OF CONSTRUCTION

#### TABLE 601

DUIL DING ELEMENT	TYPE II
BUILDING ELEMENT	В
STRUCTURAL FRAME	0
BEARING WALLS EXTERIOR INTERIOR	0
NONBEARING WALLS AND PARTITIONS EXTERIOR	SEE TABLE 602
NONBEARING WALLS AND PARTITIONS INTERIOR	0
FLOOR CONSTRUCTION INCLUDING SUPPORTING BEAMS AND JOISTS	0
ROOF CONSTRUCTION INCLUDING SUPPORTING BEAMS AND JOISTS	0

#### TABLE 602

EXTERIOR WALLS HAS A FIRE SEPARATION DISTANCE GREATER THAN 30'. NON OF THE EXTERIOR WALLS ARE REQUIRED TO BE FIRE RATTED

#### CHAPTER 7 FIRE AND SMOKE PROTECTION:

TABLE 705.8 ALL EXTERIOR WALLS HAS A FIRE SEPARATION DISTANCE GREATER THAN 30'. UNLIMITED AMOUNT OF OPENINGS ARE PERMITTED IN THE EXTERIOR WALLS

#### CHAPTER 8 INTERIOR FINISHES:

TABLE 803.11 INTERIOR WALL AND CEILING FINISH REQUIREMENTS BY OCCUPANCY

#### GROUP S-1 GROUP B VERTICAL EXITS AND PASSAGE WAYS EXIT ACCESS CORRIDORS AND OTHER EXIT WAYS ROOMS AND ENCLOSED SPACES

## CHAPTER 9-FIRE PROTECTION SYSTEMS :

NOT REQUIRED WHEN BUILDING IS EQUIPPED WITH AN E.S.F.R. SYSTEM

(903.2)	SPRINKLER SYSTEM	-REQUIRED	PROVIDED
	R. SYSTEM PROVIDED THROUGHOUT MONITORING AND ALARM SYSTEMS		
(905)	STAND PIPE	NOT REQUIRED	NOT PROVIDED
(906.1)	PORTABLE FIRE EXTINGUISHERS	-REQUIRED	PROVIDED
(910.2)	SMOKE AND HEAT VENTS	NOT REQUIRED	NOT PROVIDED

#### **CHAPTER 10 MEANS OF EGRESS:**

```
TABLE 1004.1.2 OCCUPANT LOAD CALCULATIONS
    \frac{\text{FIRST FLOOR}}{\text{WAREHOUSE (S-1)}} \quad 515,888 \text{ SF} / 500 \text{ SF GROSS} = 1,032 \text{ OCCUPANTS}
     OFFICES (B) 46,562 \text{ SF}/100 \text{ SF GROSS} = 466 \text{ OCCUPANTS}
                                TOTAL FIRST FLOOR 1,498 OCCUPANTS
     MEZZANINE
OFFICES (B) (FUTURE) 46,562 SF/ 100 SF GROSS = 466 OCCUPANTS
                            TOTAL MEZZANINE FLOOR 466 OCCUPANTS
                                                      1,964 OCCUPANTS
                                  TOTAL BUILDING
```

#### CHAPTER 10 MEANS OF EGRESS:

#### SECTION 1006 NUMBER OF EXITS AND EXIT ACCESS DOORWAYS

MAIN FLOOR 4 EXIT REQUIRED 38 EXITS PROVIDED <u>MEZZANINE</u> 2 EXIT REQUIRED 8 EXIT PROVIDED

FIRST FLOOR EGRESS CODE ANALYSIS							
	REQUIRED	PROVIDED					
1,785 OCCUPANTS							
1005 7 2	0.15" PER OCCUPANT	6,696"					
1005.3.2	267.75"						
1020.2	44" MINIMUM						
1005 3 1	0.2" PER OCCUPANT	N/A					
1005.5.1	N/A	14/ / /					
1017.2	300 FEET	<300 FEET					
1017.2.2	400 FEET	<400 FEET					
1020.1	O	0					
1020.4	50 FEET MAX	<50 FEET					
	1,785 OCCUPANTS 1005.3.2 1020.2 1005.3.1 1017.2 1017.2.2 1020.1	REQUIRED					

MEZZANINE EGRESS CODE ANALYSIS						
		REQUIRED	PROVIDED			
TOTAL OCCUPANTS	471 OCCUPANTS					
	1005.3.2	0.15" PER OCCUPANT				
EGRESS WIDTH		70.65"	384"			
	1020.2	44" MINIMUM				
STAIRWAY EGRESS WIDTH	1005.3.1	0.2" PER OCCUPANT	384"			
MINIM CCANDA I FAMAIRIC	1003.3.1	83.4"	504			
EXIT ACCESS TRAVEL DISTANCE OFFICE	1017.2	300 FEET	<300 FEET			
CORRIDOR FIRE-RESISTANCE RATING	1020.1	0	0			
CORRIDOR DEAD END	1020.4	50 FEET MAX	<50 FEET			






WARNING: IT IS A VIOLATION OF NY STATE EDUCATION LAW, ARTICLE 145, SECTION 7209 FOR ANY PERSON, UNLESS ACTING UNDER THE DIRECTION OF A LICENSED PROFESSIONAL ENGINEER OR ARCHITECT, TO ALTER THES DOCUMENTS IN ANY WAY. IF ALTERED, THE ALTERING ENGINEER/ARCHITEC SHALL AFFIX HIS OR HER SEAL AND THE NOTATION "ALTERED BY" FOLLOWED BY HIS OR HER SIGNATURE, THE DATE OF SUCH ALTERATION, AND A SPECIFIC DESCRIPTION OF THE ALTERATION.

WRITTEN STATEMENT

TO THE BEST OF MY KNOWLEDGE, BELIEF AND PROFESSIONAL JUDGMENT, THESE PLANS AND SPECIFICATIONS ARE IN COMPLIANCE WITH THE NEW YORK STATE UNIFORM FIRE PREVENTION AND BUILDING CODE AND THE NEW YORK STATE ENERGY CONSERVATION CONSTRUCTION CODE, AS CURRENTLY

Drawn By: HDT Reviewed By: JR Date AUG. 18, 2022 Revisions:

Project No. 181101

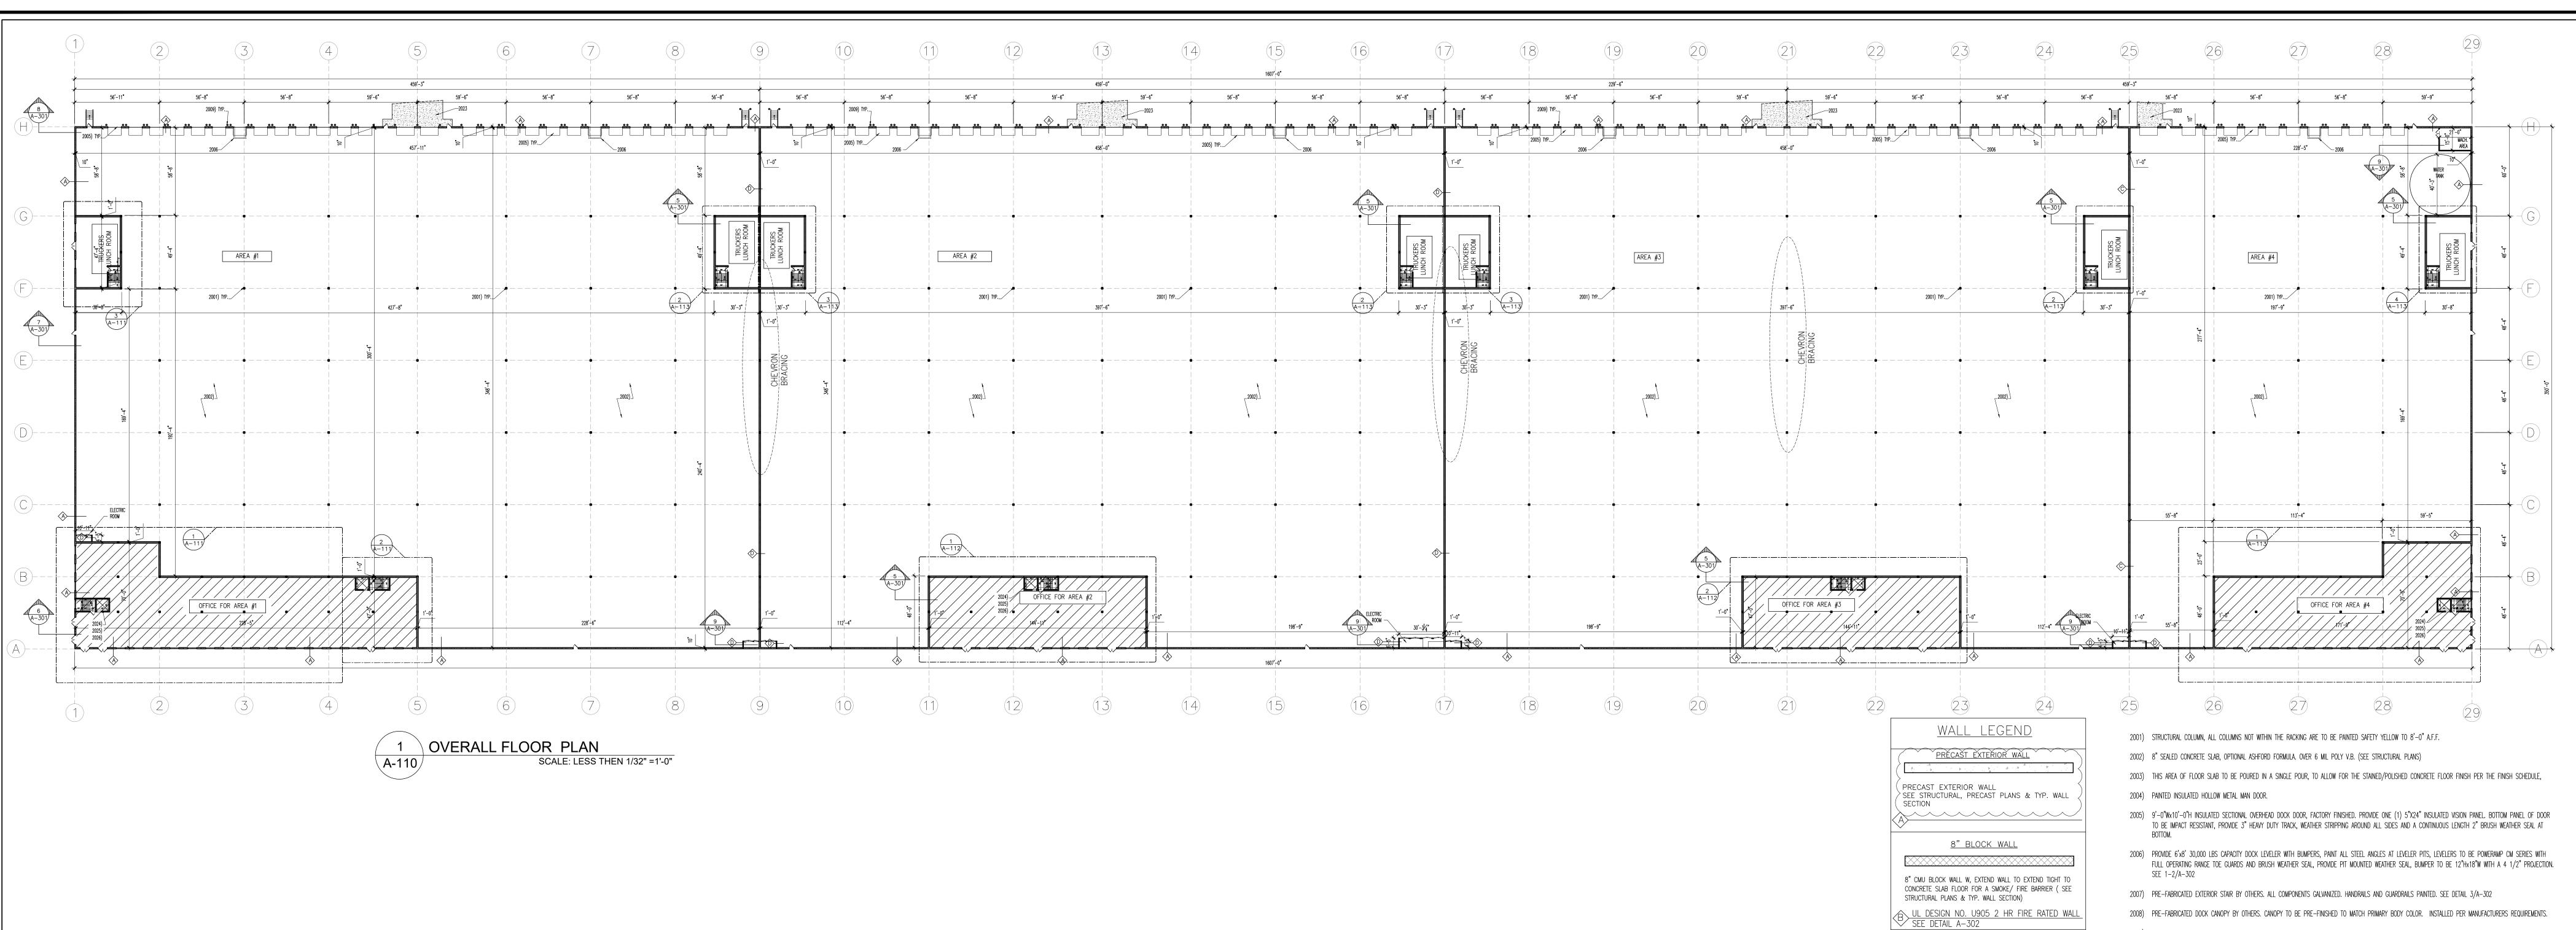

<u>square footage</u>: 145,368 S.F. TRUCKERS LUNCH ROOM 2,960 S.F. OFFICE FOR AREAS #1 12,413 S.F. 150,673 S.F. TRUCKERS LUNCH ROOM 2,924 S.F. OFFICE FOR AREAS #2 7,052 S.F. 150,673 S.F. AREA #3 TRUCKERS LUNCH ROOM 2,924 S.F. OFFICE FOR AREAS #3 7,052 S.F. 69,174 S.F. | AREA #4 TRUCKERS LUNCH ROOM 1,498 S.F. 36,256 S.F. TOTAL TRUCKERS 10,306 S.F. 515,888 S.F. TOTAL WAREHOUSE 562,450 S.F.

$\overline{\ \ \ \ \ \ \ \ \ \ }$	<u>/INDOW</u>	AND		DR_	SCHEDULE
QNTY.	DESIGNATION	OPE WIDTH	NING HEIGHT		
88	LOADING DOCKS	9'-0"	10'-0"		
7	DRIVE-INS	12'-0"	10'-0"		
	DOOR	3'-0"	8'-0"		

2008) PRE-FABRICATED DOCK CANOPY BY OTHERS. CANOPY TO BE PRE-FINISHED TO MATCH PRIMARY BODY COLOR. INSTALLED PER MANUFACTURERS REQUIREMENTS.

2009) CONCRETE FILLED STEEL BOLLARD, PAINTED SAFETY YELLOW.

2010) PROVIDE DOCK SHELTER, DOCK SHELTER TO BE FAIRBORN SERIES 2000 RIGID DOCK SHELTER.

2011) PROVIDE 42" SWING ARM LED DOCK LIGHTS.

<u>12" BLOCK WALL</u>

12" CMU BLOCK WALL W, EXTEND WALL TO EXTEND TIGHT TO CONCRETE SLAB FLOOR FOR A SMOKE/ FIRE BARRIER ( SEE

UL DESIGN NO. U905 2 HR FIRE RATED WALL
SEE DETAIL A-302

INTERIOR WALL

4" METAL STUDS W/ (1) LAYER OF %" GYPSUM

SMOKE/ FIRE BARRIER

BOARD. (WATER-RESISTANT ON WET WALLS). WALL TO EXTEND TIGHT TO CONCRETE SLAB FLOOR FOR A

UL DESIGN NO. U404 1 HR FIRE RATED WALL
SEE DETAIL A-302

<u>PLUMBING WALL</u>

(1) CMU BLOCK WALL (1) 4" METAL STUDS WALL @

16" O.C. W/ (2) LAYERS OF %" WATER-RESISTANT TYPE "X" GYPSUM BOARD. WALL TO EXTEND TIGHT TO

CONCRETE SLAB FLOOR FOR A SMOKE/ FIRE BARRIER

UL DESIGN NO. U420 2 HR FIRE RATED WALL

NOISE BARRIER FENCE

4" METAL STUDS W/2" STUCCO FINISH ROUGH

SURFACES ON BOTH SIDES

STRUCTURAL PLANS & TYP. WALL SECTION)

2012) ALL DOCKS DOORS TO RECEIVE LAMINATED WHEEL CHOCK, GALVANIZED CHAIN, AND BUILDING MOUNTED SIGN. CHAIN TO BE 20'-0" LONG AND HAVE A MINIMUM SIZE OF 3/16".

2013) PROVIDE TWO (2) WALL MOUNTED REFLECTIVE GUIDES MOUNTED UNDER THE SHELTERS OR VERTICAL PADS AT ALL DOCK DOOR AND KNOCK OUT POSITIONS.

2014) PROVIDE DOCK POSITION NUMBERING FOR ALL DOCK DOORS AND KNOCKOUT POSITIONS ON INTERIOR SIDE. NUMBERS LOCATED AT DOCK DOORS ARE TO BE MOUNTED ON DOCK DOOR, NUMBERS LOCATED AT KNOCK OUTS ARE TO BE MOUNTED ON THE WALL PANELS. NUMBERING TO BE PER MEDLINE STANDARDS AND SHOULD MATCH THE EXTERIOR SEQUENCE.

2015) PAINT THE INTERIOR FACE OF THE CONCRETE WALL PANELS WITHIN THE WAREHOUSE, ALL CONDUITS AND PIPES ON THE EXTERIOR WALLS ARE TO BE PAINTED TO

2016) CONCRETE RETAINING WALL PAINT TO MATCH ADJACENT WALL.

2017) FLOOR FINISH.

2018) WALL-MOUNTED/COLUMN MOUNTED FIRE EXTINGUISHER, #3005 BY POTTER-ROEMER, 2A:10B:C, WITH WALL BRACKET.

2019) PROVIDE LABELS ON ALL FIRE RISERS, LABEL TO BE VINYL STICKER OR STENCILED ON EACH RISER. NUMBER TO BE RED 6" HIGH ARIAL FONT. POSITION BOTTOM OF NUMBER AT 10'-0" A.F.F.

2020) ALL ROOF DRAIN LEADERS ARE TO BE PROTECTED BY PREFABRICATED PIPE GUARDS. PIPE GUARDS ARE TO BE WALL MOUNTED, 36" HIGH WITH SAFETY YELLOW FACTORY FINISH.

2021) PICK MODULE COLUN BY OTHERS UNDER SEPERATE PERMIT, SHOWN FOR REFERENCE ONLY.

2022) PROVIDE DOOR NUMBERS FOR ALL DOCK DOORS AND KNOCK-OUTS, DOCK DOORS AND KNOCK-OUTS ARE TO BE NUMBERED SEQUENTIALLY, NUMBERING SHOULD BE RAISED NUMBERS WITH ARIAL FONT, 1'-3"H, MOUNT BOTTOM OF NUMBERS AT 16'-4" A.F.F.

2023) CAST IN PLACE DRIVE IN RAMP (SEE STRUCTURAL PLANS)

2024) ELEVATOR MANUFACTURER SHALL SUBMIT ELEVATOR PLANS COMPLYING WITH SECTION 30 OF THE IBC AND SHOULD BE APPROVED PRIOR TO FABRICATION AND INSTALLATION

2025) PIT TO BE 4'-0" VERIFY WITH ELEVATOR MANUFACTURER'S SPECIFICATIONS.

2026) PROVIDE A SUMP PUMP, LADDER, LIGHT FOR ELEVATOR PIT 2027) PROVIDE À NOISE ÀBATÉMENT FENCE. SEE DETAIL 6/A-302

412 N. MAIN STREET. SUITE 301 MONROE NY 10950 845-781-4222 LARRY@LHARTMANDESIGN.COM




VARNING: IT IS A VIOLATION OF NY STATE EDUCATION LAW, ARTICLE 145 SECTION 7209 FOR ANY PERSON, UNLESS ACTING UNDER THE DIRECTIO OF A LICENSED PROFESSIONAL ENGINEER OR ARCHITECT, TO ALTER THES DOCUMENTS IN ANY WAY. IF ALTERED, THE ALTERING ENGINEER/ARCHITEC SHALL AFFIX HIS OR HER SEAL AND THE NOTATION "ALTERED BY" FOLLOWED BY HIS OR HER SIGNATURE, THE DATE OF SUCH ALTERATION,

TO THE BEST OF MY KNOWLEDGE, BELIEF AND PROFESSIONAL JUDGMENT,

HESE PLANS AND SPECIFICATIONS ARE IN COMPLIANCE WITH THE NEW YORK STATE UNIFORM FIRE PREVENTION AND BUILDING CODE AND THE NEW YORK STATE ENERGY CONSERVATION CONSTRUCTION CODE, AS CURRENTLY Project No. 181101

Drawn By: HDT Reviewed By: JR Date AUG. 18, 2022

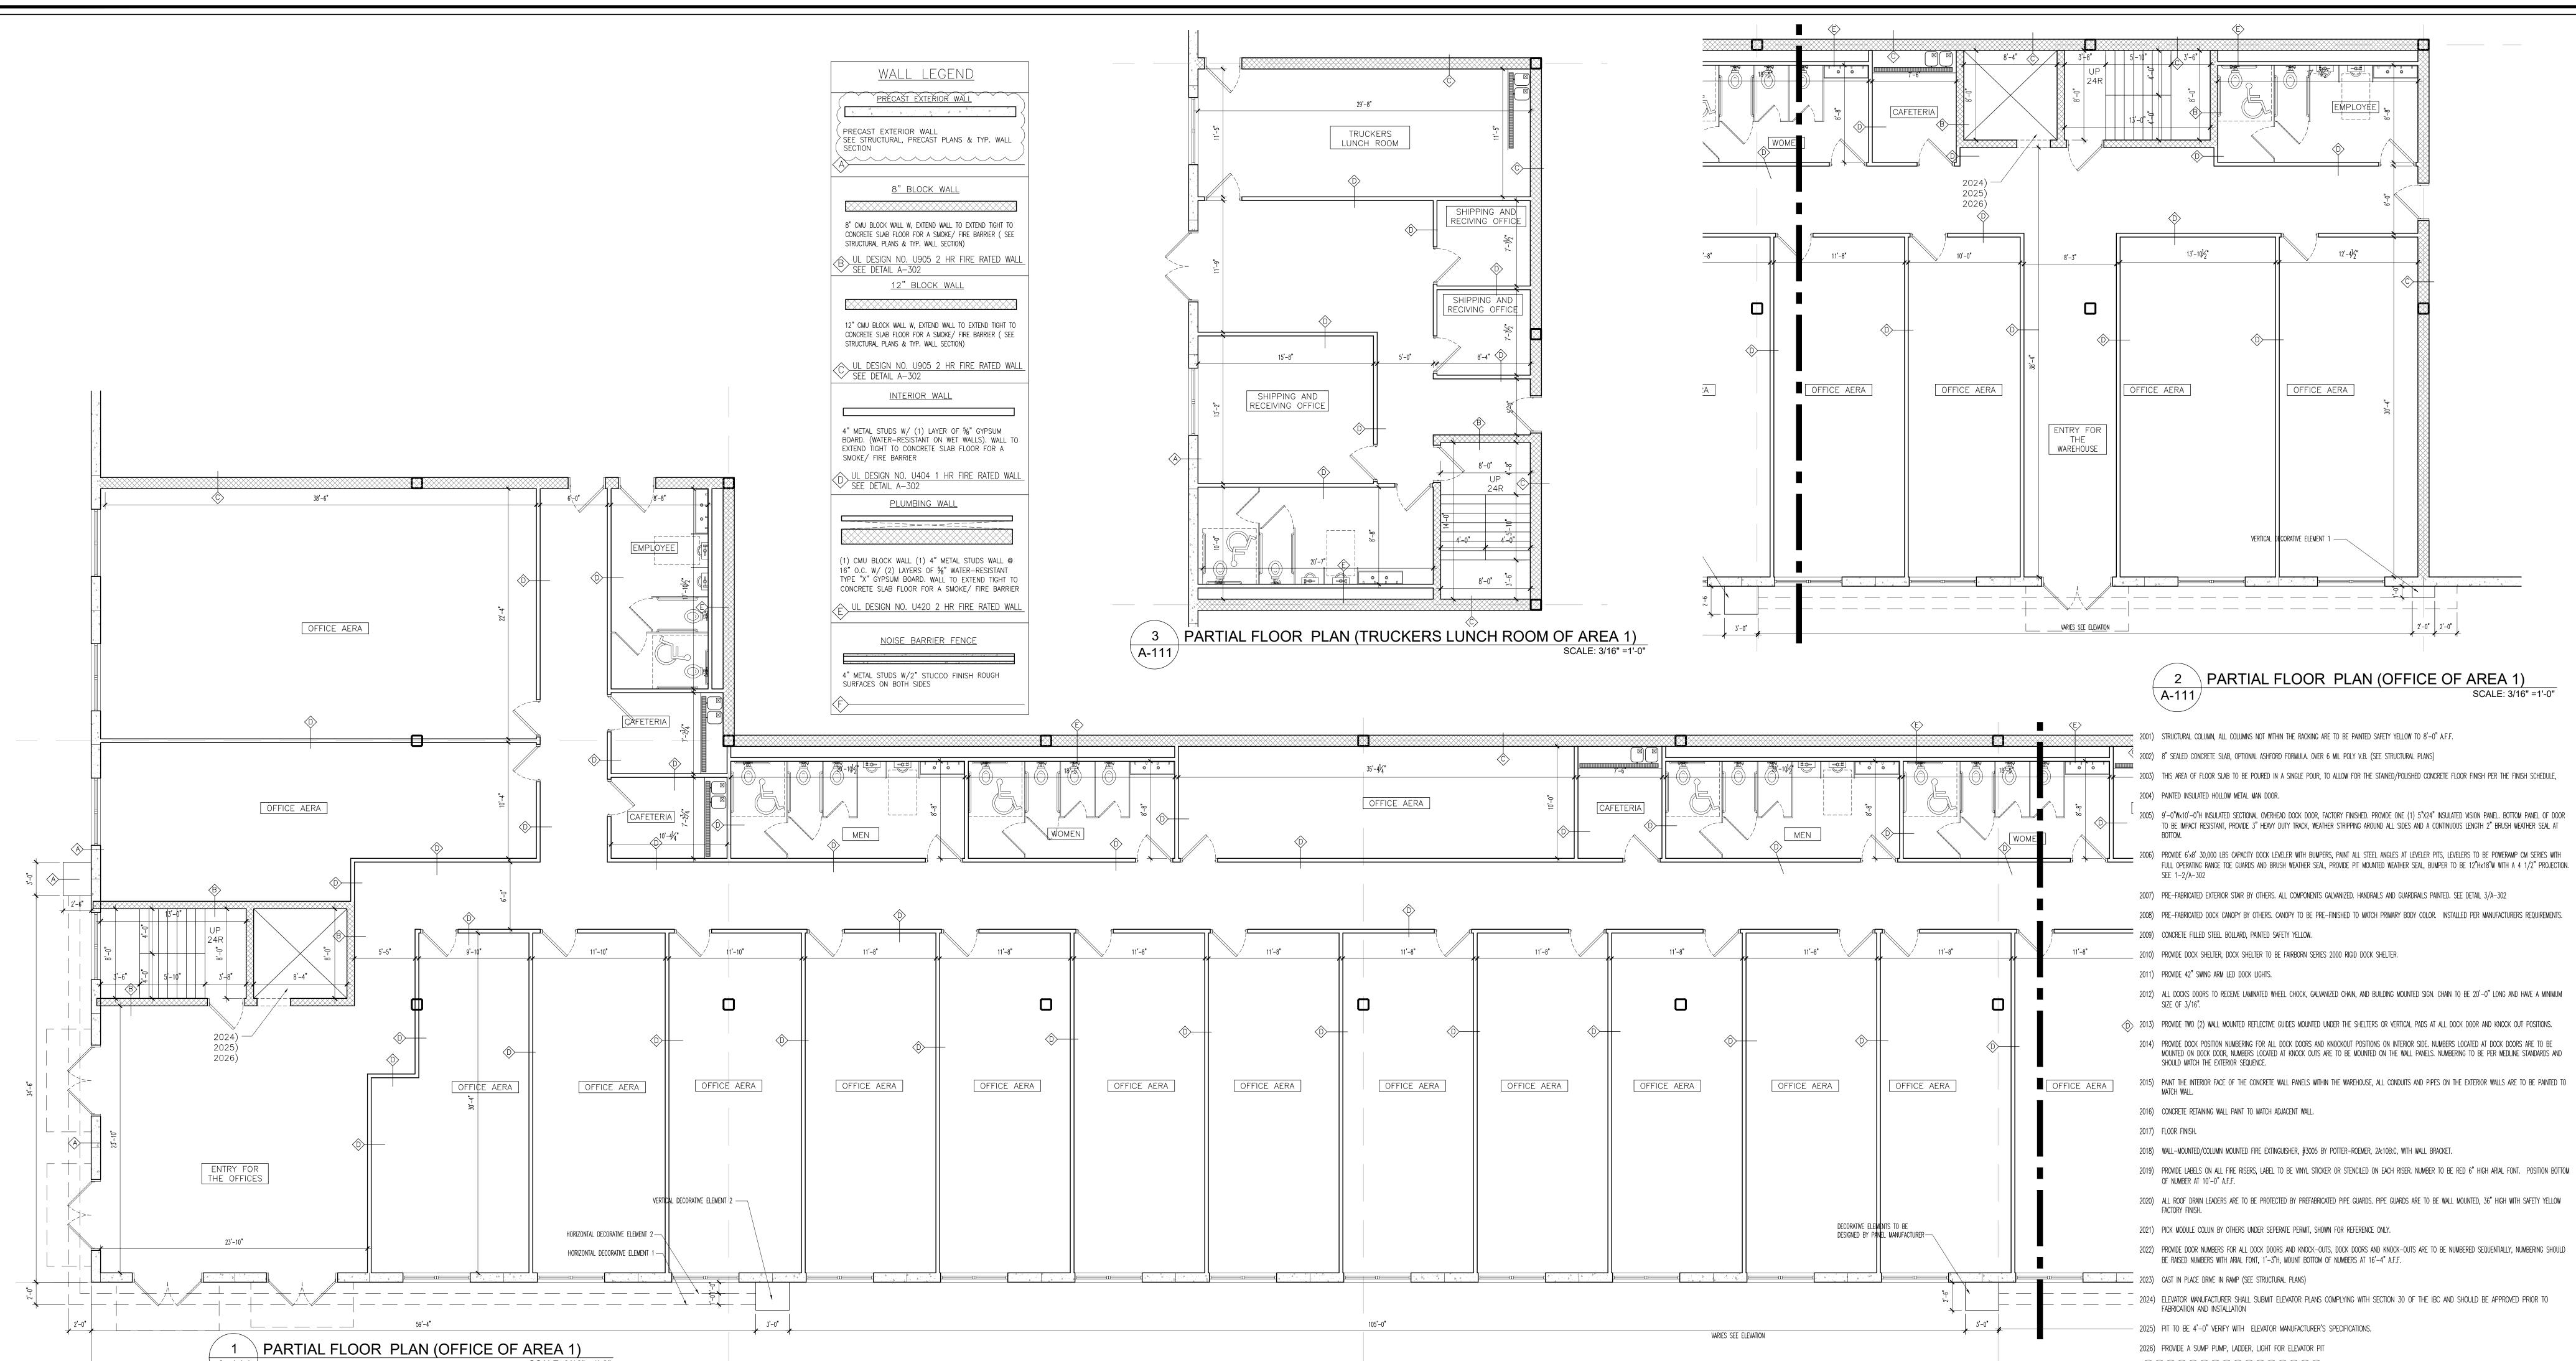

Hartman Design COMMERCIAL - RESIDENTIAL 412 N. MAIN STREET. SUITE 301 MONROE NY 10950 845-781-4222 LARRY@LHARTMANDESIGN.COM



LICENSE NO: 082844

WARNING: IT IS A VIOLATION OF NY STATE EDUCATION LAW, ARTICLE 145, SECTION 7209 FOR ANY PERSON, UNLESS ACTING UNDER THE DIRECTION OF A LICENSED PROFESSIONAL ENGINEER OR ARCHITECT, TO ALTER THES DOCUMENTS IN ANY WAY. IF ALTERED, THE ALTERING ENGINEER/ARCHITEC SHALL AFFIX HIS OR HER SEAL AND THE NOTATION "ALTERED BY" FOLLOWED BY HIS OR HER SIGNATURE, THE DATE OF SUCH ALTERATION,

AND A SPECIFIC DESCRIPTION OF THE ALTERATION.

MOUNTED ON DOCK DOOR, NUMBERS LOCATED AT KNOCK OUTS ARE TO BE MOUNTED ON THE WALL PANELS. NUMBERING TO BE PER MEDLINE STANDARDS AND

2019) PROVIDE LABELS ON ALL FIRE RISERS, LABEL TO BE VINYL STICKER OR STENCILED ON EACH RISER. NUMBER TO BE RED 6" HIGH ARIAL FONT. POSITION BOTTOM

2022) PROVIDE DOOR NUMBERS FOR ALL DOCK DOORS AND KNOCK-OUTS, DOCK DOORS AND KNOCK-OUTS ARE TO BE NUMBERED SEQUENTIALLY, NUMBERING SHOULD

2024) ELEVATOR MANUFACTURER SHALL SUBMIT ELEVATOR PLANS COMPLYING WITH SECTION 30 OF THE IBC AND SHOULD BE APPROVED PRIOR TO

(2027) PŘOVÍDE A NÔISE ABATÉMENT FENČE. ŠEE DETÁIL 6/A-302 

O THE BEST OF MY KNOWLEDGE, BELIEF AND PROFESSIONAL JUDGMENT,

HESE PLANS AND SPECIFICATIONS ARE IN COMPLIANCE WITH THE NEW YORK STATE UNIFORM FIRE PREVENTION AND BUILDING CODE AND THE NEW YORK STATE ENERGY CONSERVATION CONSTRUCTION CODE, AS CURRENTLY


Project No. 181101 Drawn By: HDT

Date AUG. 18, 2022

/22/2022 Revised to smaller foot print /26/2023 Revised as per B.D

29/2024 Revised as per P.B.

Reviewed By: JR

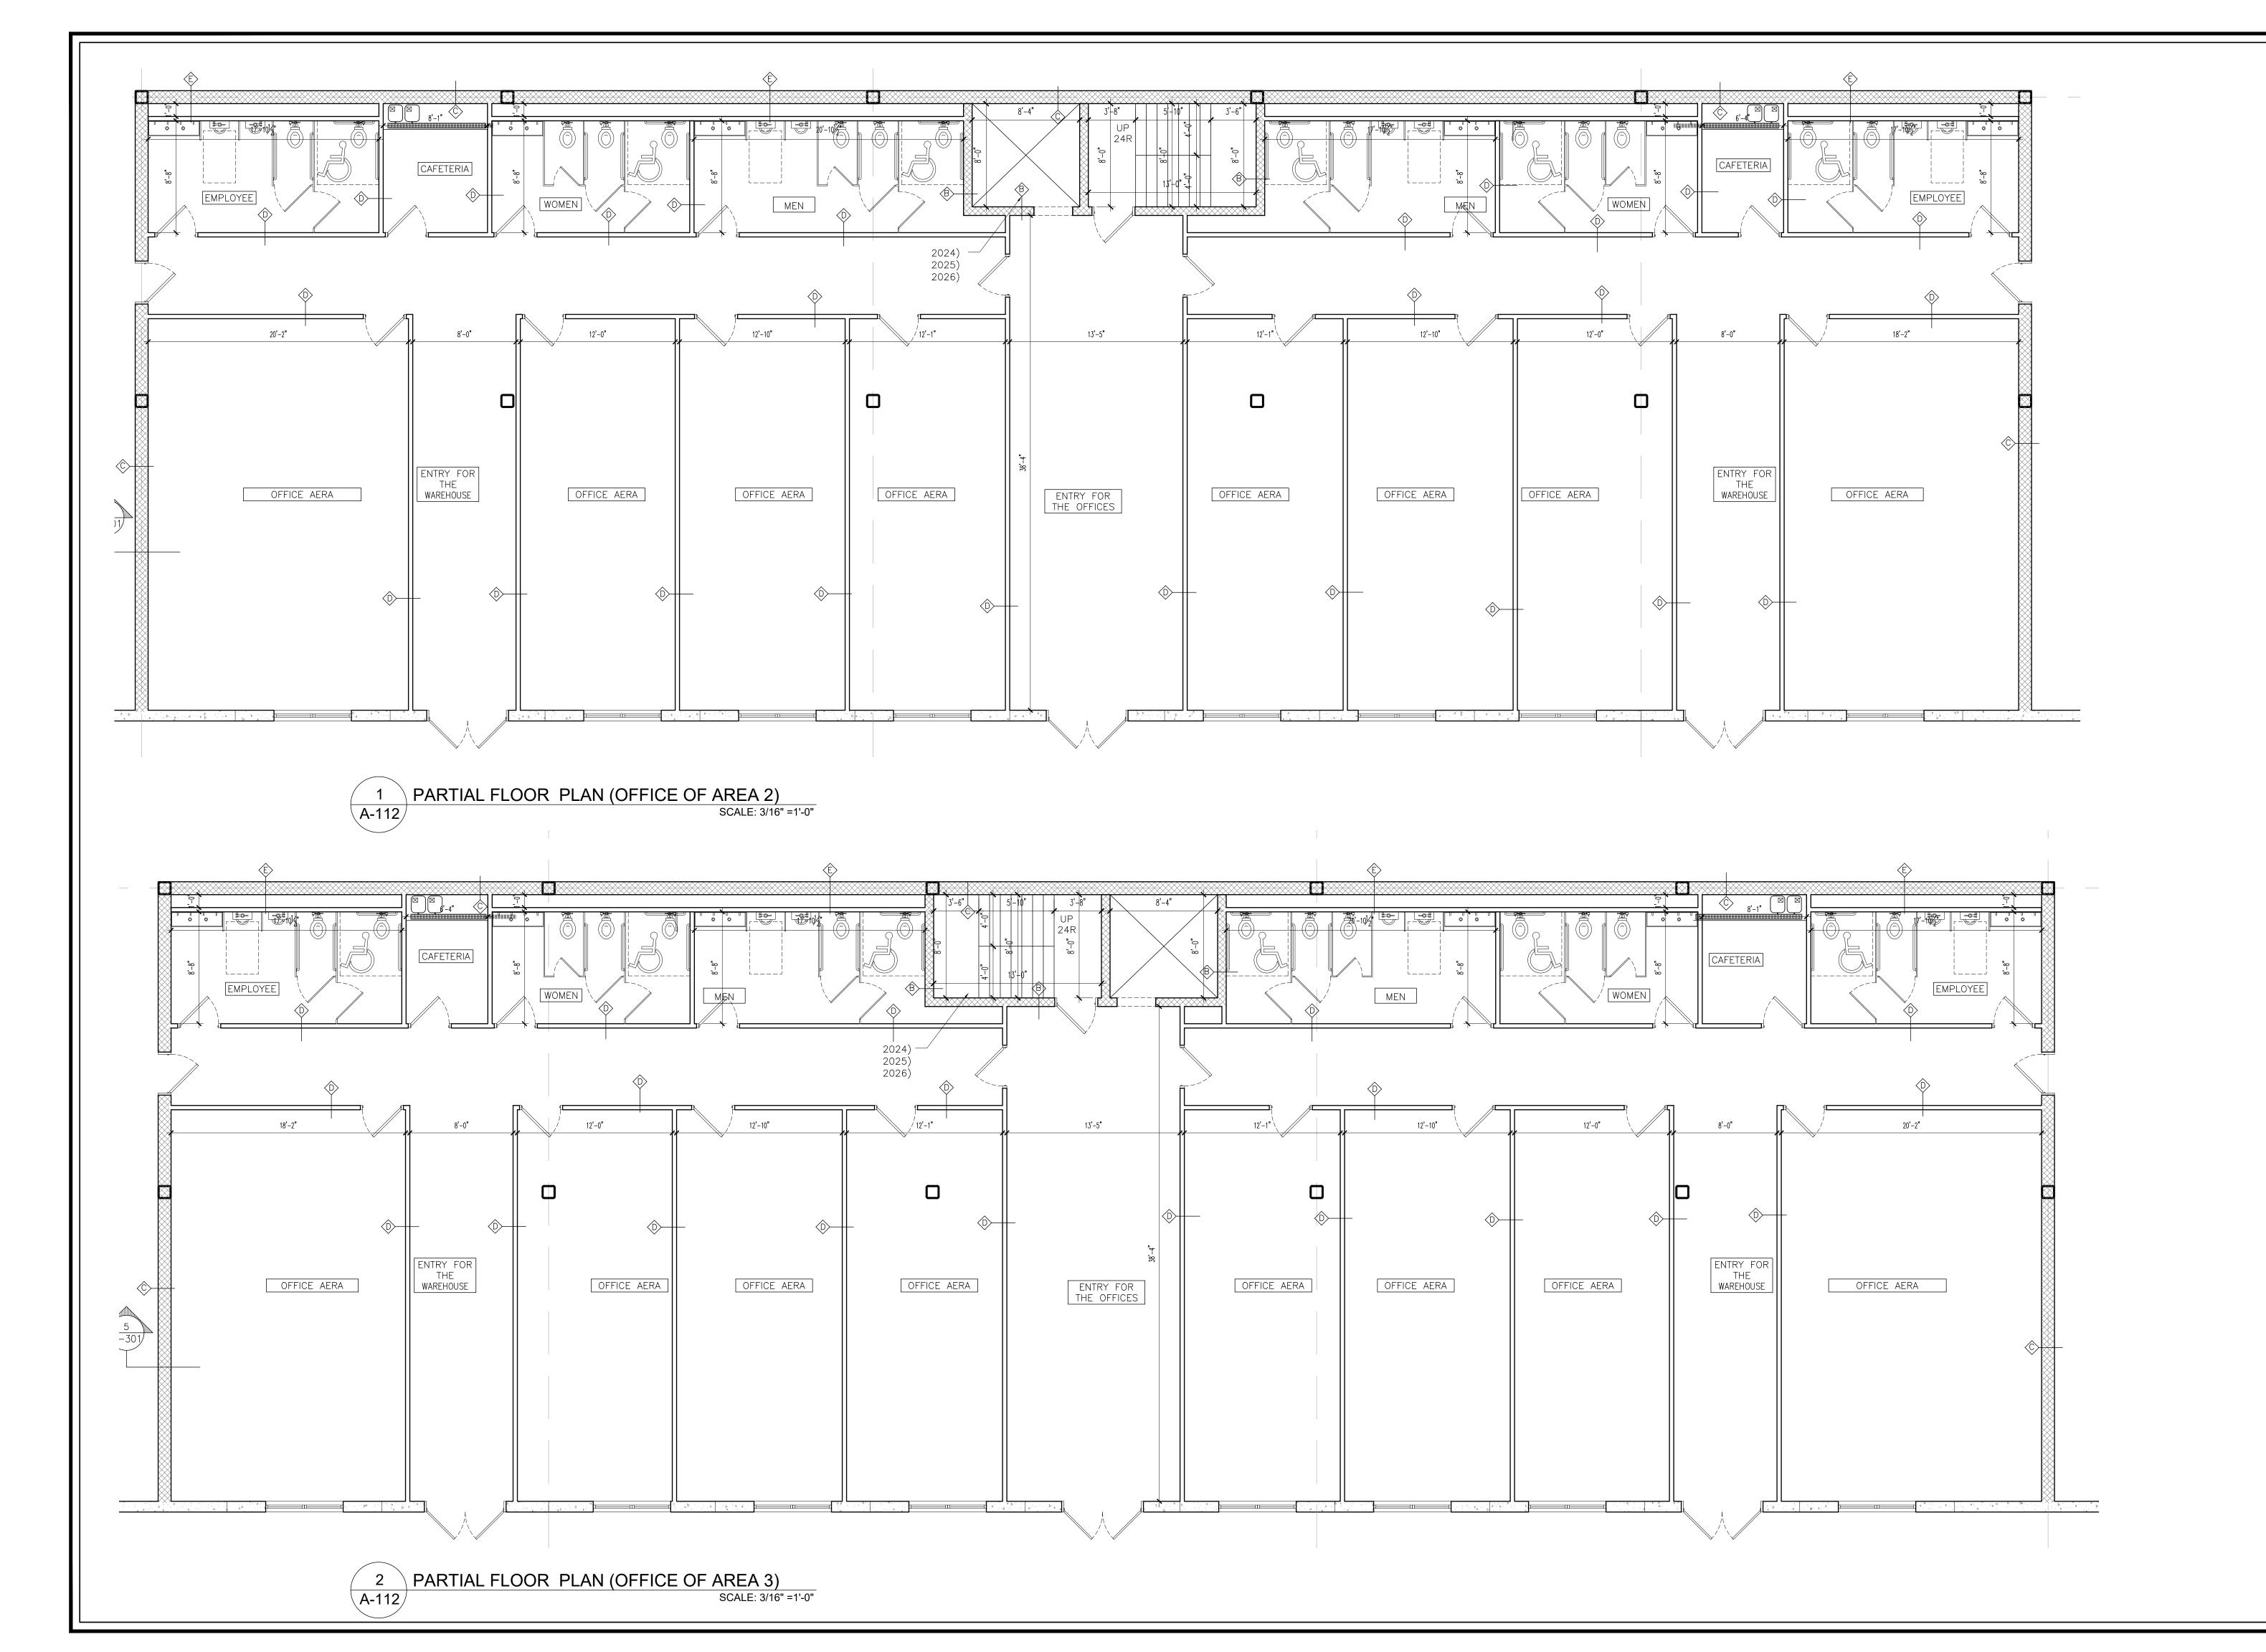

PRÉCAST EXTERIOR WALL

SEE STRUCTURAL, PRECAST PLANS & TYP. WALL

<u>8" BLOCK WALL</u>

8" CMU BLOCK WALL W, EXTEND WALL TO EXTEND TIGHT TO CONCRETE SLAB FLOOR FOR A SMOKE/ FIRE BARRIER ( SEE

<u>12" BLOCK WALL</u>

12" CMU BLOCK WALL W, EXTEND WALL TO EXTEND TIGHT TO

CONCRETE SLAB FLOOR FOR A SMOKE/ FIRE BARRIER ( SEE

UL DESIGN NO. U905 2 HR FIRE RATED WALL SEE DETAIL A-302

INTERIOR WALL

4" METAL STUDS W/ (1) LAYER OF %" GYPSUM

SMOKE/ FIRE BARRIER

SEE DETAIL A-302

BOARD. (WATER-RESISTANT ON WET WALLS). WALL TO EXTEND TIGHT TO CONCRETE SLAB FLOOR FOR A

UL DESIGN NO. U404 1 HR FIRE RATED WALL

PLUMBING WALL

(1) CMU BLOCK WALL (1) 4" METAL STUDS WALL @ 16" O.C. W/ (2) LAYERS OF %" WATER-RESISTANT

TYPE "X" GYPSUM BOARD. WALL TO EXTEND TIGHT TO CONCRETE SLAB FLOOR FOR A SMOKE/ FIRE BARRIER

- UL DESIGN NO. U420 2 HR FIRE RATED WAL

NOISE BARRIER FENCE

4" METAL STUDS W/2" STUCCO FINISH ROUGH

SURFACES ON BOTH SIDES

STRUCTURAL PLANS & TYP. WALL SECTION)

STRUCTURAL PLANS & TYP. WALL SECTION)

PRECAST EXTERIOR WALL

2003) THIS AREA OF FLOOR SLAB TO BE POURED IN A SINGLE POUR, TO ALLOW FOR THE STAINED/POLISHED CONCRETE FLOOR FINISH PER THE FINISH SCHEDULE,

2004) PAINTED INSULATED HOLLOW METAL MAN DOOR.

2005) 9'-0"Wx10'-0"H INSULATED SECTIONAL OVERHEAD DOCK DOOR, FACTORY FINISHED. PROVIDE ONE (1) 5"X24" INSULATED VISION PANEL. BOTTOM PANEL OF DOOR TO BE IMPACT RESISTANT, PROVIDE 3" HEAVY DUTY TRACK, WEATHER STRIPPING AROUND ALL SIDES AND A CONTINUOUS LENGTH 2" BRUSH WEATHER SEAL AT

2006) PROVIDE 6'x8' 30,000 LBS CAPACITY DOCK LEVELER WITH BUMPERS, PAINT ALL STEEL ANGLES AT LEVELER PITS, LEVELERS TO BE POWERAMP CM SERIES WITH FULL OPERATING RANGE TOE GUARDS AND BRUSH WEATHER SEAL, PROVIDE PIT MOUNTED WEATHER SEAL, BUMPER TO BE 12"Hx18"W WITH A 4 1/2" PROJECTION.

2007) PRE-FABRICATED EXTERIOR STAIR BY OTHERS. ALL COMPONENTS GALVANIZED. HANDRAILS AND GUARDRAILS PAINTED. SEE DETAIL 3/A-302

BUL DESIGN NO. U905 2 HR FIRE RATED WALL SEE DETAIL A-302 2008) PRE-FABRICATED DOCK CANOPY BY OTHERS. CANOPY TO BE PRE-FINISHED TO MATCH PRIMARY BODY COLOR. INSTALLED PER MANUFACTURERS REQUIREMENTS.

2009) CONCRETE FILLED STEEL BOLLARD, PAINTED SAFETY YELLOW.

2010) PROVIDE DOCK SHELTER, DOCK SHELTER TO BE FAIRBORN SERIES 2000 RIGID DOCK SHELTER.

2011) PROVIDE 42" SWING ARM LED DOCK LIGHTS.

2012) ALL DOCKS DOORS TO RECEIVE LAMINATED WHEEL CHOCK, GALVANIZED CHAIN, AND BUILDING MOUNTED SIGN. CHAIN TO BE 20'-0" LONG AND HAVE A MINIMUM

2013) PROVIDE TWO (2) WALL MOUNTED REFLECTIVE GUIDES MOUNTED UNDER THE SHELTERS OR VERTICAL PADS AT ALL DOCK DOOR AND KNOCK OUT POSITIONS.

2014) PROVIDE DOCK POSITION NUMBERING FOR ALL DOCK DOORS AND KNOCKOUT POSITIONS ON INTERIOR SIDE. NUMBERS LOCATED AT DOCK DOORS ARE TO BE MOUNTED ON DOCK DOOR, NUMBERS LOCATED AT KNOCK OUTS ARE TO BE MOUNTED ON THE WALL PANELS. NUMBERING TO BE PER MEDLINE STANDARDS AND

2015) PAINT THE INTERIOR FACE OF THE CONCRETE WALL PANELS WITHIN THE WAREHOUSE, ALL CONDUITS AND PIPES ON THE EXTERIOR WALLS ARE TO BE PAINTED TO MATCH WALL.

2016) CONCRETE RETAINING WALL PAINT TO MATCH ADJACENT WALL.

2018) WALL-MOUNTED/COLUMN MOUNTED FIRE EXTINGUISHER, #3005 BY POTTER-ROEMER, 2A:10B:C, WITH WALL BRACKET.

2019) PROVIDE LABELS ON ALL FIRE RISERS, LABEL TO BE VINYL STICKER OR STENCILED ON EACH RISER. NUMBER TO BE RED 6" HIGH ARIAL FONT. POSITION BOTTOM OF NUMBER AT 10'-0" A.F.F.

2020) ALL ROOF DRAIN LEADERS ARE TO BE PROTECTED BY PREFABRICATED PIPE GUARDS. PIPE GUARDS ARE TO BE WALL MOUNTED, 36" HIGH WITH SAFETY YELLOW FACTORY FINISH.

2021) PICK MODULE COLUN BY OTHERS UNDER SEPERATE PERMIT, SHOWN FOR REFERENCE ONLY.

2022) PROVIDE DOOR NUMBERS FOR ALL DOCK DOORS AND KNOCK-OUTS, DOCK DOORS AND KNOCK-OUTS ARE TO BE NUMBERED SEQUENTIALLY, NUMBERING SHOULD

FABRICATION AND INSTALLATION

2027) PROVIDE A NOISE ABATEMENT FENCE. SEE DETAIL 6/A-302 

2001) STRUCTURAL COLUMN, ALL COLUMNS NOT WITHIN THE RACKING ARE TO BE PAINTED SAFETY YELLOW TO 8'-0" A.F.F.

2002) 8" SEALED CONCRETE SLAB, OPTIONAL ASHFORD FORMULA. OVER 6 MIL POLY V.B. (SEE STRUCTURAL PLANS)

SHOULD MATCH THE EXTERIOR SEQUENCE.

BE RAISED NUMBERS WITH ARIAL FONT, 1'-3"H, MOUNT BOTTOM OF NUMBERS AT 16'-4" A.F.F.

2023) CAST IN PLACE DRIVE IN RAMP (SEE STRUCTURAL PLANS)

2024) ELEVATOR MANUFACTURER SHALL SUBMIT ELEVATOR PLANS COMPLYING WITH SECTION 30 OF THE IBC AND SHOULD BE APPROVED PRIOR TO

2025) PIT TO BE 4'-0" VERIFY WITH ELEVATOR MANUFACTURER'S SPECIFICATIONS.

2026) PROVIDE A SUMP PUMP, LADDER, LIGHT FOR ELEVATOR PIT

LICENSE NO: 082844

Hartman Design COMMERCIAL - RESIDENTIAL

412 N. MAIN STREET. SUITE 301 MONROE NY 10950 845-781-4222


LARRY@LHARTMANDESIGN.COM

WARNING: IT IS A VIOLATION OF NY STATE EDUCATION LAW, ARTICLE 145 SECTION 7209 FOR ANY PERSON, UNLESS ACTING UNDER THE DIRECTION OF A LICENSED PROFESSIONAL ENGINEER OR ARCHITECT, TO ALTER THES DOCUMENTS IN ANY WAY. IF ALTERED, THE ALTERING ENGINEER/ARCHITEC SHALL AFFIX HIS OR HER SEAL AND THE NOTATION "ALTERED BY" FOLLOWED BY HIS OR HER SIGNATURE, THE DATE OF SUCH ALTERATION, AND A SPECIFIC DESCRIPTION OF THE ALTERATION.

TO THE BEST OF MY KNOWLEDGE, BELIEF AND PROFESSIONAL JUDGMENT, THESE PLANS AND SPECIFICATIONS ARE IN COMPLIANCE WITH THE NEW YORK STATE UNIFORM FIRE PREVENTION AND BUILDING CODE AND THE NEW YORK STATE ENERGY CONSERVATION CONSTRUCTION CODE, AS CURRENTLY

Project No. 181101 Drawn By: HD1

Reviewed By: JR Date AUG. 18, 2022

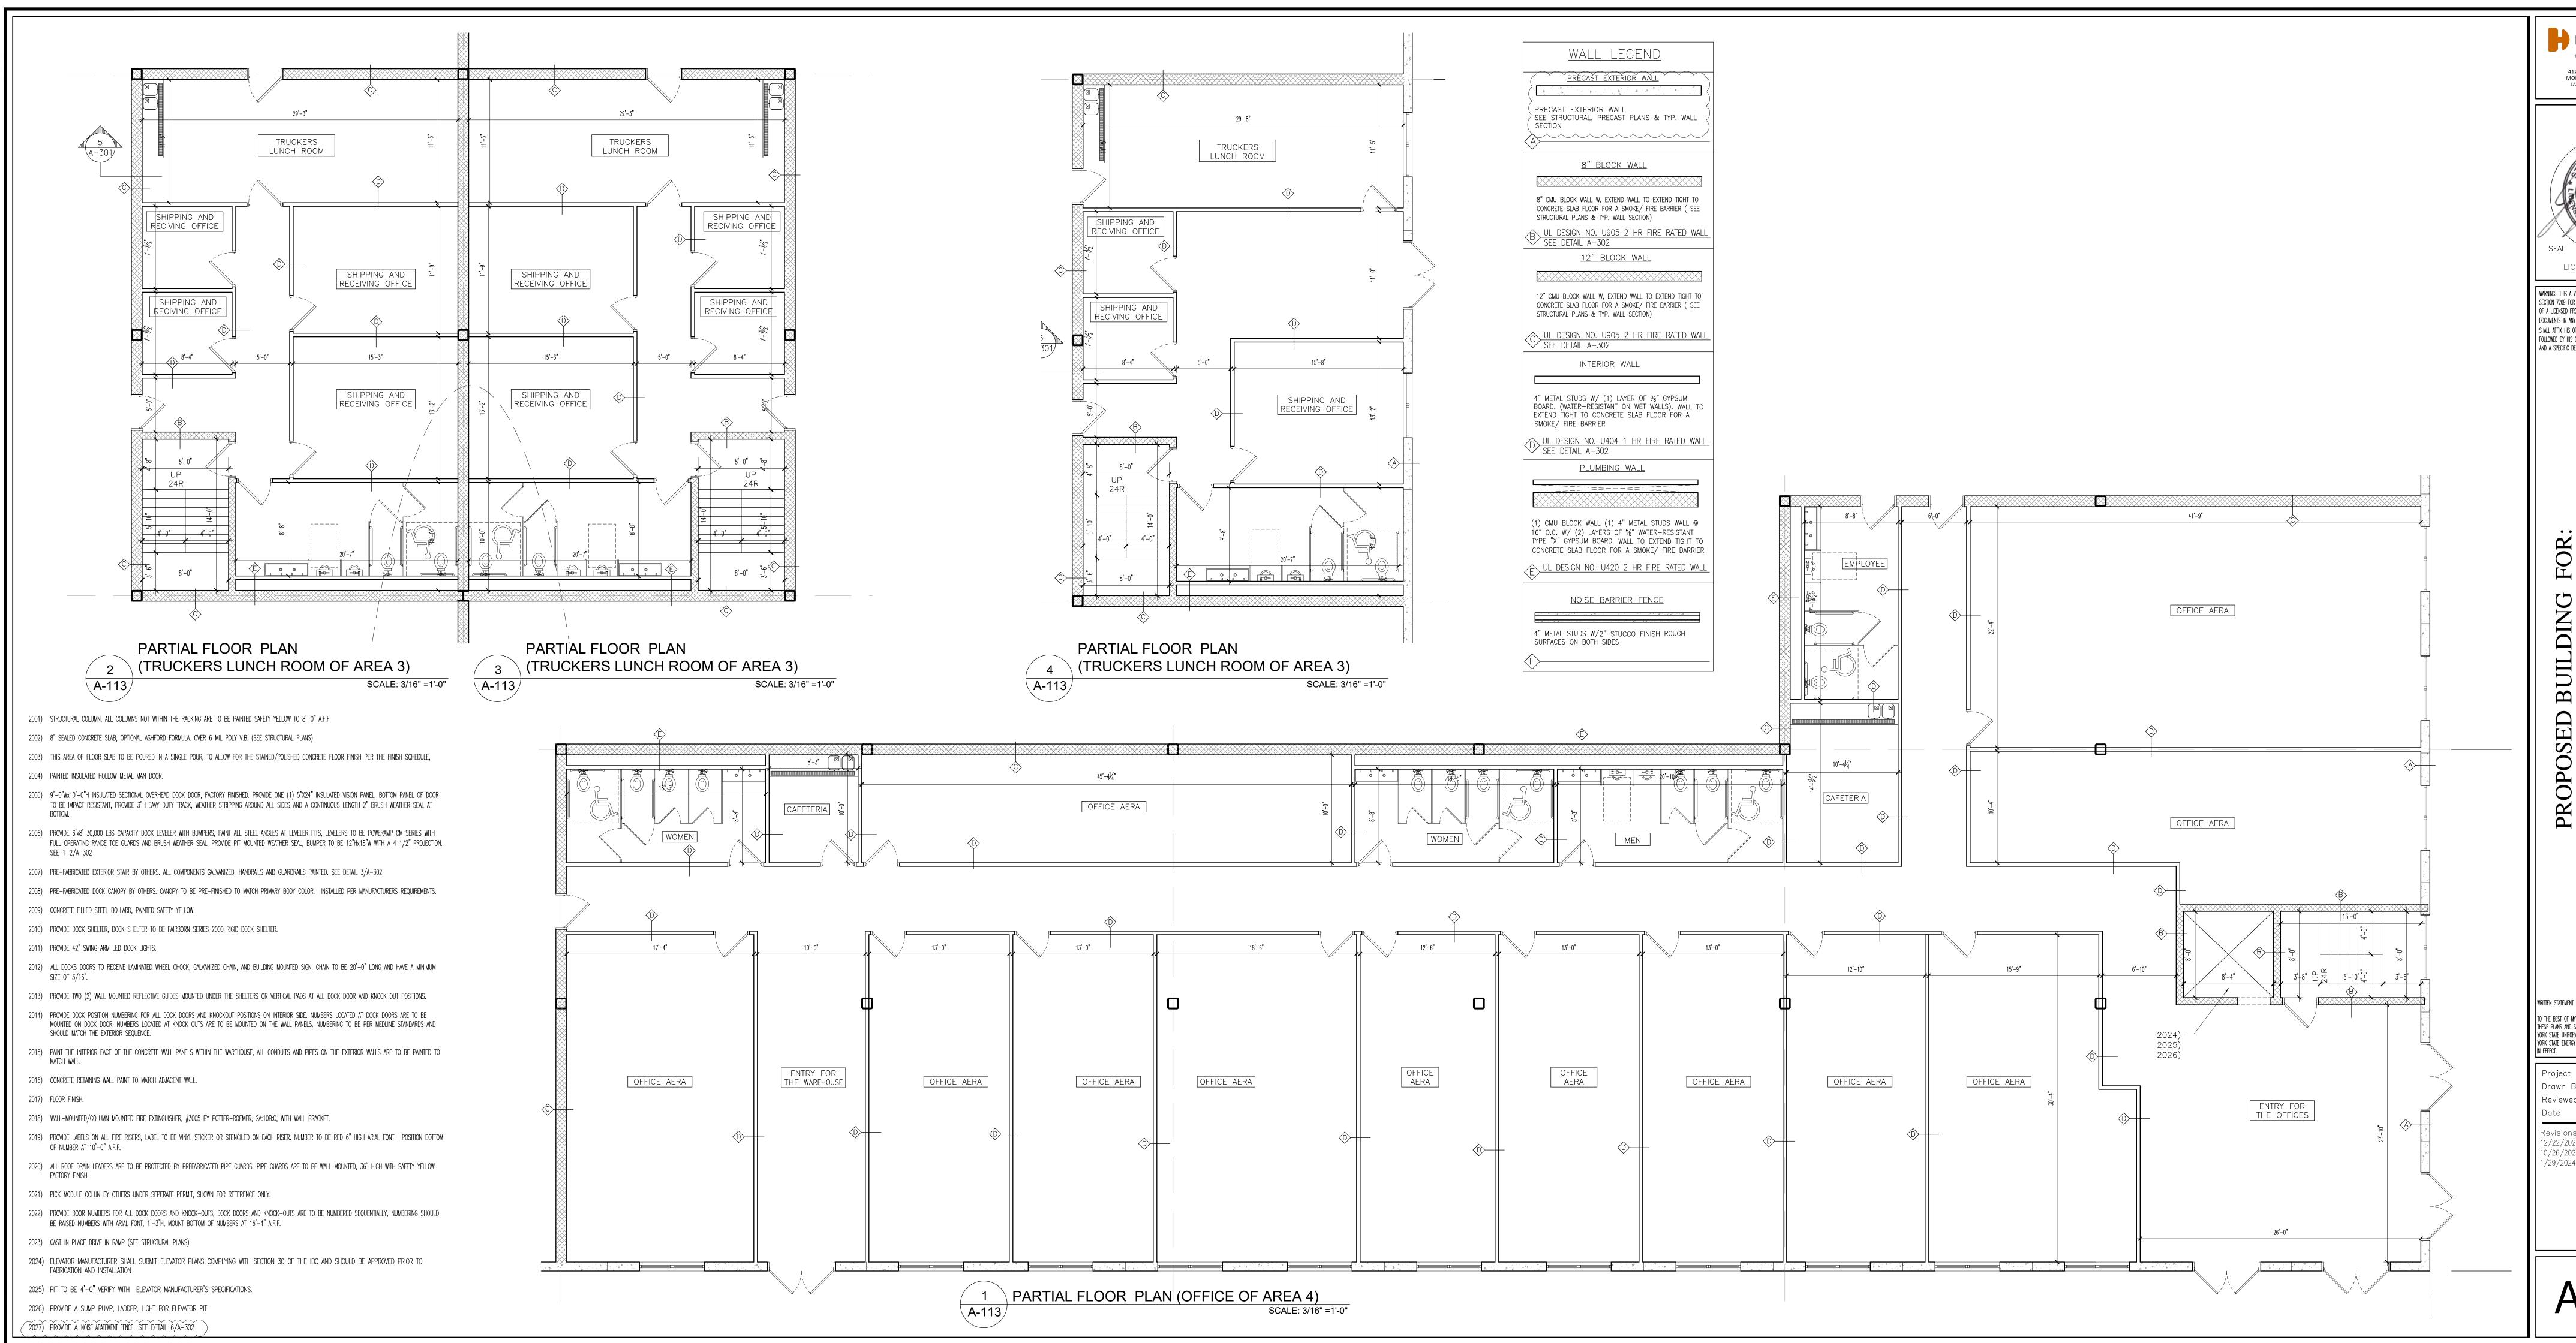

LICENSE NO: 082844

WARNING: IT IS A VIOLATION OF NY STATE EDUCATION LAW, ARTICLE 145 SECTION 7209 FOR ANY PERSON, UNLESS ACTING UNDER THE DIRECTION OF A LICENSED PROFESSIONAL ENGINEER OR ARCHITECT, TO ALTER THES DOCUMENTS IN ANY WAY. IF ALTERED, THE ALTERING ENGINEER/ARCHITEC SHALL AFFIX HIS OR HER SEAL AND THE NOTATION "ALTERED BY" FOLLOWED BY HIS OR HER SIGNATURE, THE DATE OF SUCH ALTERATION, AND A SPECIFIC DESCRIPTION OF THE ALTERATION.


TO THE BEST OF MY KNOWLEDGE, BELIEF AND PROFESSIONAL JUDGMENT,

HESE PLANS AND SPECIFICATIONS ARE IN COMPLIANCE WITH THE NEW YORK STATE UNIFORM FIRE PREVENTION AND BUILDING CODE AND THE NE YORK STATE ENERGY CONSERVATION CONSTRUCTION CODE, AS CURRENTLY

Project No. 181101 Drawn By: HDT Reviewed By: JR Date AUG. 18, 2022

Revisions: 2/22/2022 Revised to smaller foot print 0/26/2023 Revised as per B.D

1/29/2024 Revised as per P.B.

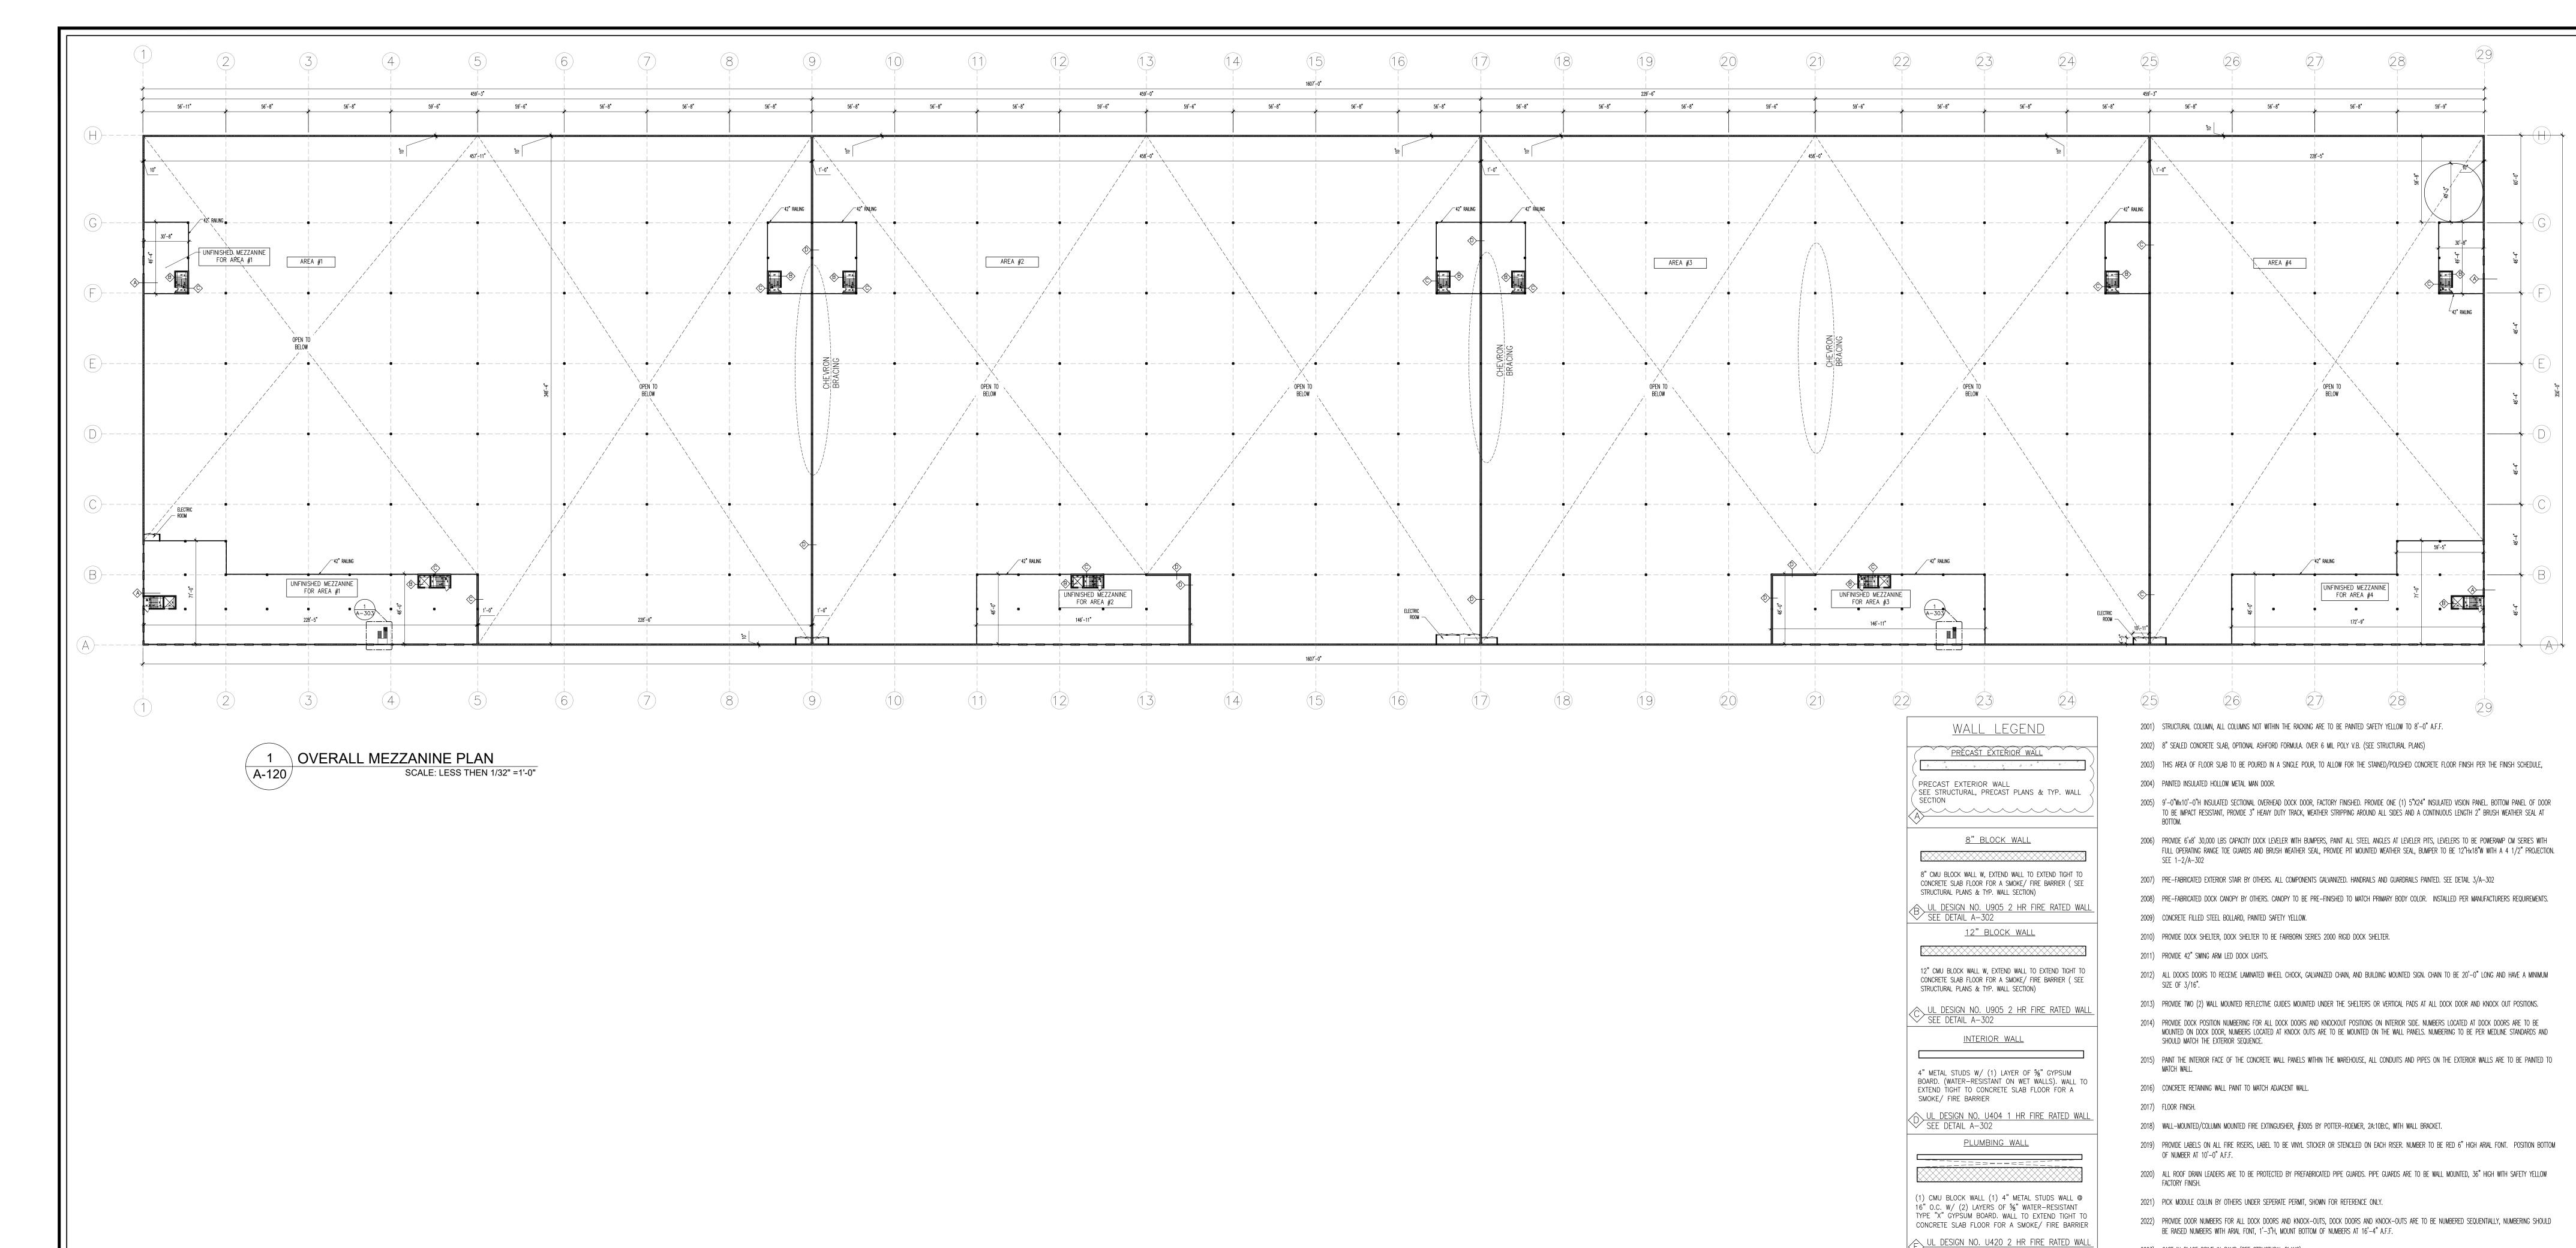

412 N. MAIN STREET. SUITE 301 MONROE NY 10950 845-781-4222 LARRY@LHARTMANDESIGN.COM



WARNING: IT IS A VIOLATION OF NY STATE EDUCATION LAW, ARTICLE 145 SECTION 7209 FOR ANY PERSON, UNLESS ACTING UNDER THE DIRECTION OF A LICENSED PROFESSIONAL ENGINEER OR ARCHITECT, TO ALTER THES DOCUMENTS IN ANY WAY. IF ALTERED, THE ALTERING ENGINEER/ARCHITEC SHALL AFFIX HIS OR HER SEAL AND THE NOTATION "ALTERED BY" FOLLOWED BY HIS OR HER SIGNATURE, THE DATE OF SUCH ALTERATION,

AND A SPECIFIC DESCRIPTION OF THE ALTERATION.

TO THE BEST OF MY KNOWLEDGE, BELIEF AND PROFESSIONAL JUDGMENT, HESE PLANS AND SPECIFICATIONS ARE IN COMPLIANCE WITH THE NEW YORK STATE UNIFORM FIRE PREVENTION AND BUILDING CODE AND THE NEW YORK STATE ENERGY CONSERVATION CONSTRUCTION CODE, AS CURRENTLY

Project No. 181101 Drawn By: HDT Reviewed By: JR

Date AUG. 18, 2022

2023) CAST IN PLACE DRIVE IN RAMP (SEE STRUCTURAL PLANS)

2026) PROVIDE A SUMP PUMP, LADDER, LIGHT FOR ELEVATOR PIT

(2027) PROVÍDE A NOISE ABATÉMENT FENČE. ŠEE DETÁIL 6/A-302 

2025) PIT TO BE 4'-0" VERIFY WITH ELEVATOR MANUFACTURER'S SPECIFICATIONS.


FABRICATION AND INSTALLATION

NOISE BARRIER FENCE

4" METAL STUDS W/2" STUCCO FINISH ROUGH

SURFACES ON BOTH SIDES

2024) ELEVATOR MANUFACTURER SHALL SUBMIT ELEVATOR PLANS COMPLYING WITH SECTION 30 OF THE IBC AND SHOULD BE APPROVED PRIOR TO

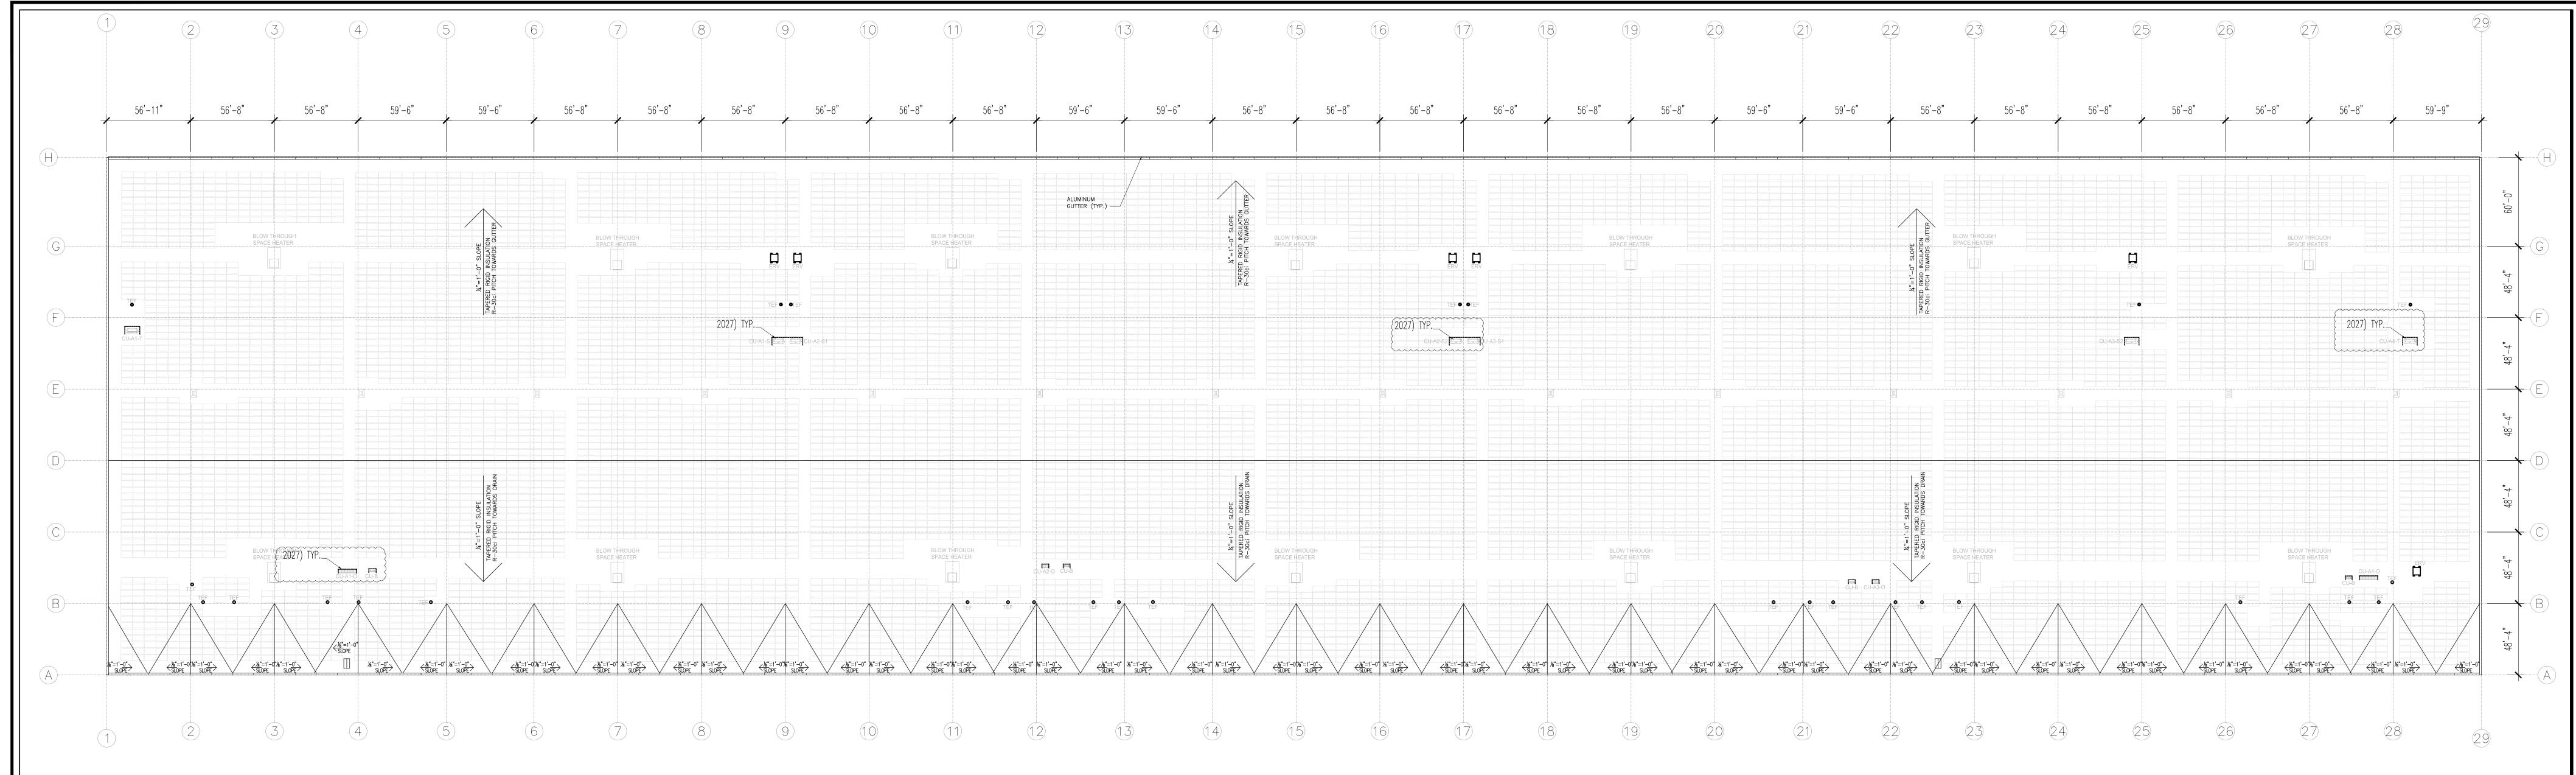

1 OVERALL ROOF PLAN
SCALE: LESS THEN 1/32" =1'-0"

- 2009) CONCRETE FILLED STEEL BOLLARD, PAINTED SAFETY YELLOW.
- 2010) PROVIDE DOCK SHELTER, DOCK SHELTER TO BE FAIRBORN SERIES 2000 RIGID DOCK SHELTER.
- 2011) PROVIDE 42" SWING ARM LED DOCK LIGHTS.
- 2012) ALL DOCKS DOORS TO RECEIVE LAMINATED WHEEL CHOCK, GALVANIZED CHAIN, AND BUILDING MOUNTED SIGN. CHAIN TO BE 20'-0" LONG AND HAVE A MINIMUM SIZE OF 3/16".
- 2013) PROVIDE TWO (2) WALL MOUNTED REFLECTIVE GUIDES MOUNTED UNDER THE SHELTERS OR VERTICAL PADS AT ALL DOCK DOOR AND KNOCK OUT POSITIONS.
- PROVIDE DOCK POSITION NUMBERING FOR ALL DOCK DOORS AND KNOCKOUT POSITIONS ON INTERIOR SIDE. NUMBERS LOCATED AT DOCK DOORS ARE TO BE MOUNTED ON DOCK DOOR, NUMBERS LOCATED AT KNOCK OUTS ARE TO BE MOUNTED ON THE WALL PANELS. NUMBERING TO BE PER MEDLINE STANDARDS AND SHOULD MATCH THE EXTERIOR SEQUENCE.
- 2015) PAINT THE INTERIOR FACE OF THE CONCRETE WALL PANELS WITHIN THE WAREHOUSE, ALL CONDUITS AND PIPES ON THE EXTERIOR WALLS ARE TO BE PAINTED TO MATCH WALL.
- 2016) CONCRETE RETAINING WALL PAINT TO MATCH ADJACENT WALL.
- 2017) FLOOR FINISH.
- 2018) WALL-MOUNTED/COLUMN MOUNTED FIRE EXTINGUISHER, #3005 BY POTTER-ROEMER, 2A:10B:C, WITH WALL BRACKET.
- 2019) PROVIDE LABELS ON ALL FIRE RISERS, LABEL TO BE VINYL STICKER OR STENCILED ON EACH RISER. NUMBER TO BE RED 6" HIGH ARIAL FONT. POSITION BOTTOM OF NUMBER AT 10'-0" A.F.F.
- 2020) ALL ROOF DRAIN LEADERS ARE TO BE PROTECTED BY PREFABRICATED PIPE GUARDS. PIPE GUARDS ARE TO BE WALL MOUNTED, 36" HIGH WITH SAFETY YELLOW FACTORY FINISH.
- 2021) PICK MODULE COLUN BY OTHERS UNDER SEPERATE PERMIT, SHOWN FOR REFERENCE ONLY.
- 2022) PROVIDE DOOR NUMBERS FOR ALL DOCK DOORS AND KNOCK-OUTS, DOCK DOORS AND KNOCK-OUTS ARE TO BE NUMBERED SEQUENTIALLY, NUMBERING SHOULD BE RAISED NUMBERS WITH ARIAL FONT, 1'-3"H, MOUNT BOTTOM OF NUMBERS AT 16'-4" A.F.F.
- 2023) CAST IN PLACE DRIVE IN RAMP (SEE STRUCTURAL PLANS)
- 2024) ELEVATOR MANUFACTURER SHALL SUBMIT ELEVATOR PLANS COMPLYING WITH SECTION 30 OF THE IBC AND SHOULD BE APPROVED PRIOR TO FABRICATION AND INSTALLATION
- 2025) PIT TO BE 4'-0" VERIFY WITH ELEVATOR MANUFACTURER'S SPECIFICATIONS.
- 2026) PROVIDE A SUMP PUMP, LADDER, LIGHT FOR ELEVATOR PIT
- 2027) PROVIDE A NOISE ABATEMENT FENCE. SEE DETAIL 6/A-302

- 2001) STRUCTURAL COLUMN, ALL COLUMNS NOT WITHIN THE RACKING ARE TO BE PAINTED SAFETY YELLOW TO 8'-0" A.F.F.
- 2002) 8" SEALED CONCRETE SLAB, OPTIONAL ASHFORD FORMULA. OVER 6 MIL POLY V.B. (SEE STRUCTURAL PLANS)
- 2003) THIS AREA OF FLOOR SLAB TO BE POURED IN A SINGLE POUR, TO ALLOW FOR THE STAINED/POLISHED CONCRETE FLOOR FINISH PER THE FINISH SCHEDULE,
- 2004) PAINTED INSULATED HOLLOW METAL MAN DOOR.
- 2005) 9'-0"Wx10'-0"H INSULATED SECTIONAL OVERHEAD DOCK DOOR, FACTORY FINISHED. PROVIDE ONE (1) 5"X24" INSULATED VISION PANEL. BOTTOM PANEL OF DOOR TO BE IMPACT RESISTANT, PROVIDE 3" HEAVY DUTY TRACK, WEATHER STRIPPING AROUND ALL SIDES AND A CONTINUOUS LENGTH 2" BRUSH WEATHER SEAL AT BOTTOM.
- 2006) PROVIDE 6'x8' 30,000 LBS CAPACITY DOCK LEVELER WITH BUMPERS, PAINT ALL STEEL ANGLES AT LEVELER PITS, LEVELERS TO BE POWERAMP CM SERIES WITH FULL OPERATING RANGE TOE GUARDS AND BRUSH WEATHER SEAL, PROVIDE PIT MOUNTED WEATHER SEAL, BUMPER TO BE 12"Hx18"W WITH A 4 1/2" PROJECTION. SEE 1-2/A-302
- 2007) PRE-FABRICATED EXTERIOR STAIR BY OTHERS. ALL COMPONENTS GALVANIZED. HANDRAILS AND GUARDRAILS PAINTED. SEE DETAIL 3/A-302
- 2008) PRE-FABRICATED DOCK CANOPY BY OTHERS. CANOPY TO BE PRE-FINISHED TO MATCH PRIMARY BODY COLOR. INSTALLED PER MANUFACTURERS REQUIREMENTS.

COMMERCIAL • RESIDENTIAL

412 N. MAIN STREET. SUITE 301
MONROE NY 10950 845-781-4222
LARRY@LHARTMANDESIGN.COM



LICENSE NO: 082844

WARNING: IT IS A VIOLATION OF NY STATE EDUCATION LAW, ARTICLE 145, SECTION 7209 FOR ANY PERSON, UNLESS ACTING UNDER THE DIRECTION OF A LICENSED PROFESSIONAL ENGINEER OR ARCHITECT, TO ALTER THESE DOCUMENTS IN ANY WAY. IF ALTERED, THE ALTERING ENGINEER/ARCHITECT SHALL AFFIX HIS OR HER SEAL AND THE NOTATION "ALTERED BY" FOLLOWED BY HIS OR HER SIGNATURE, THE DATE OF SUCH ALTERATION, AND A SPECIFIC DESCRIPTION OF THE ALTERATION.

IG FOR:

EROAD

GROVE

WYORK

PROPOSED BUILDING
1220 CRAIGVILLE
TOWN OF BLOOMING ORANGE COUNTY, NEW

itten statement

TO THE BEST OF MY KNOWLEDGE, BELIEF AND PROFESSIONAL JUDGMENT, THESE PLANS AND SPECIFICATIONS ARE IN COMPLIANCE WITH THE NEW YORK STATE UNIFORM FIRE PREVENTION AND BUILDING CODE AND THE NEW YORK STATE ENERGY CONSERVATION CONSTRUCTION CODE, AS CURRENTLY IN EFFECT.

Project No. 1ETIOI


Drawn By: HDT

Reviewed By: JR


Date AUG. 18, 2022


Revisions:
12/22/2022 Revised to smaller foot print
10/26/2023 Revised as per B.D
1/29/2024 Revised as per P.B.

A-130

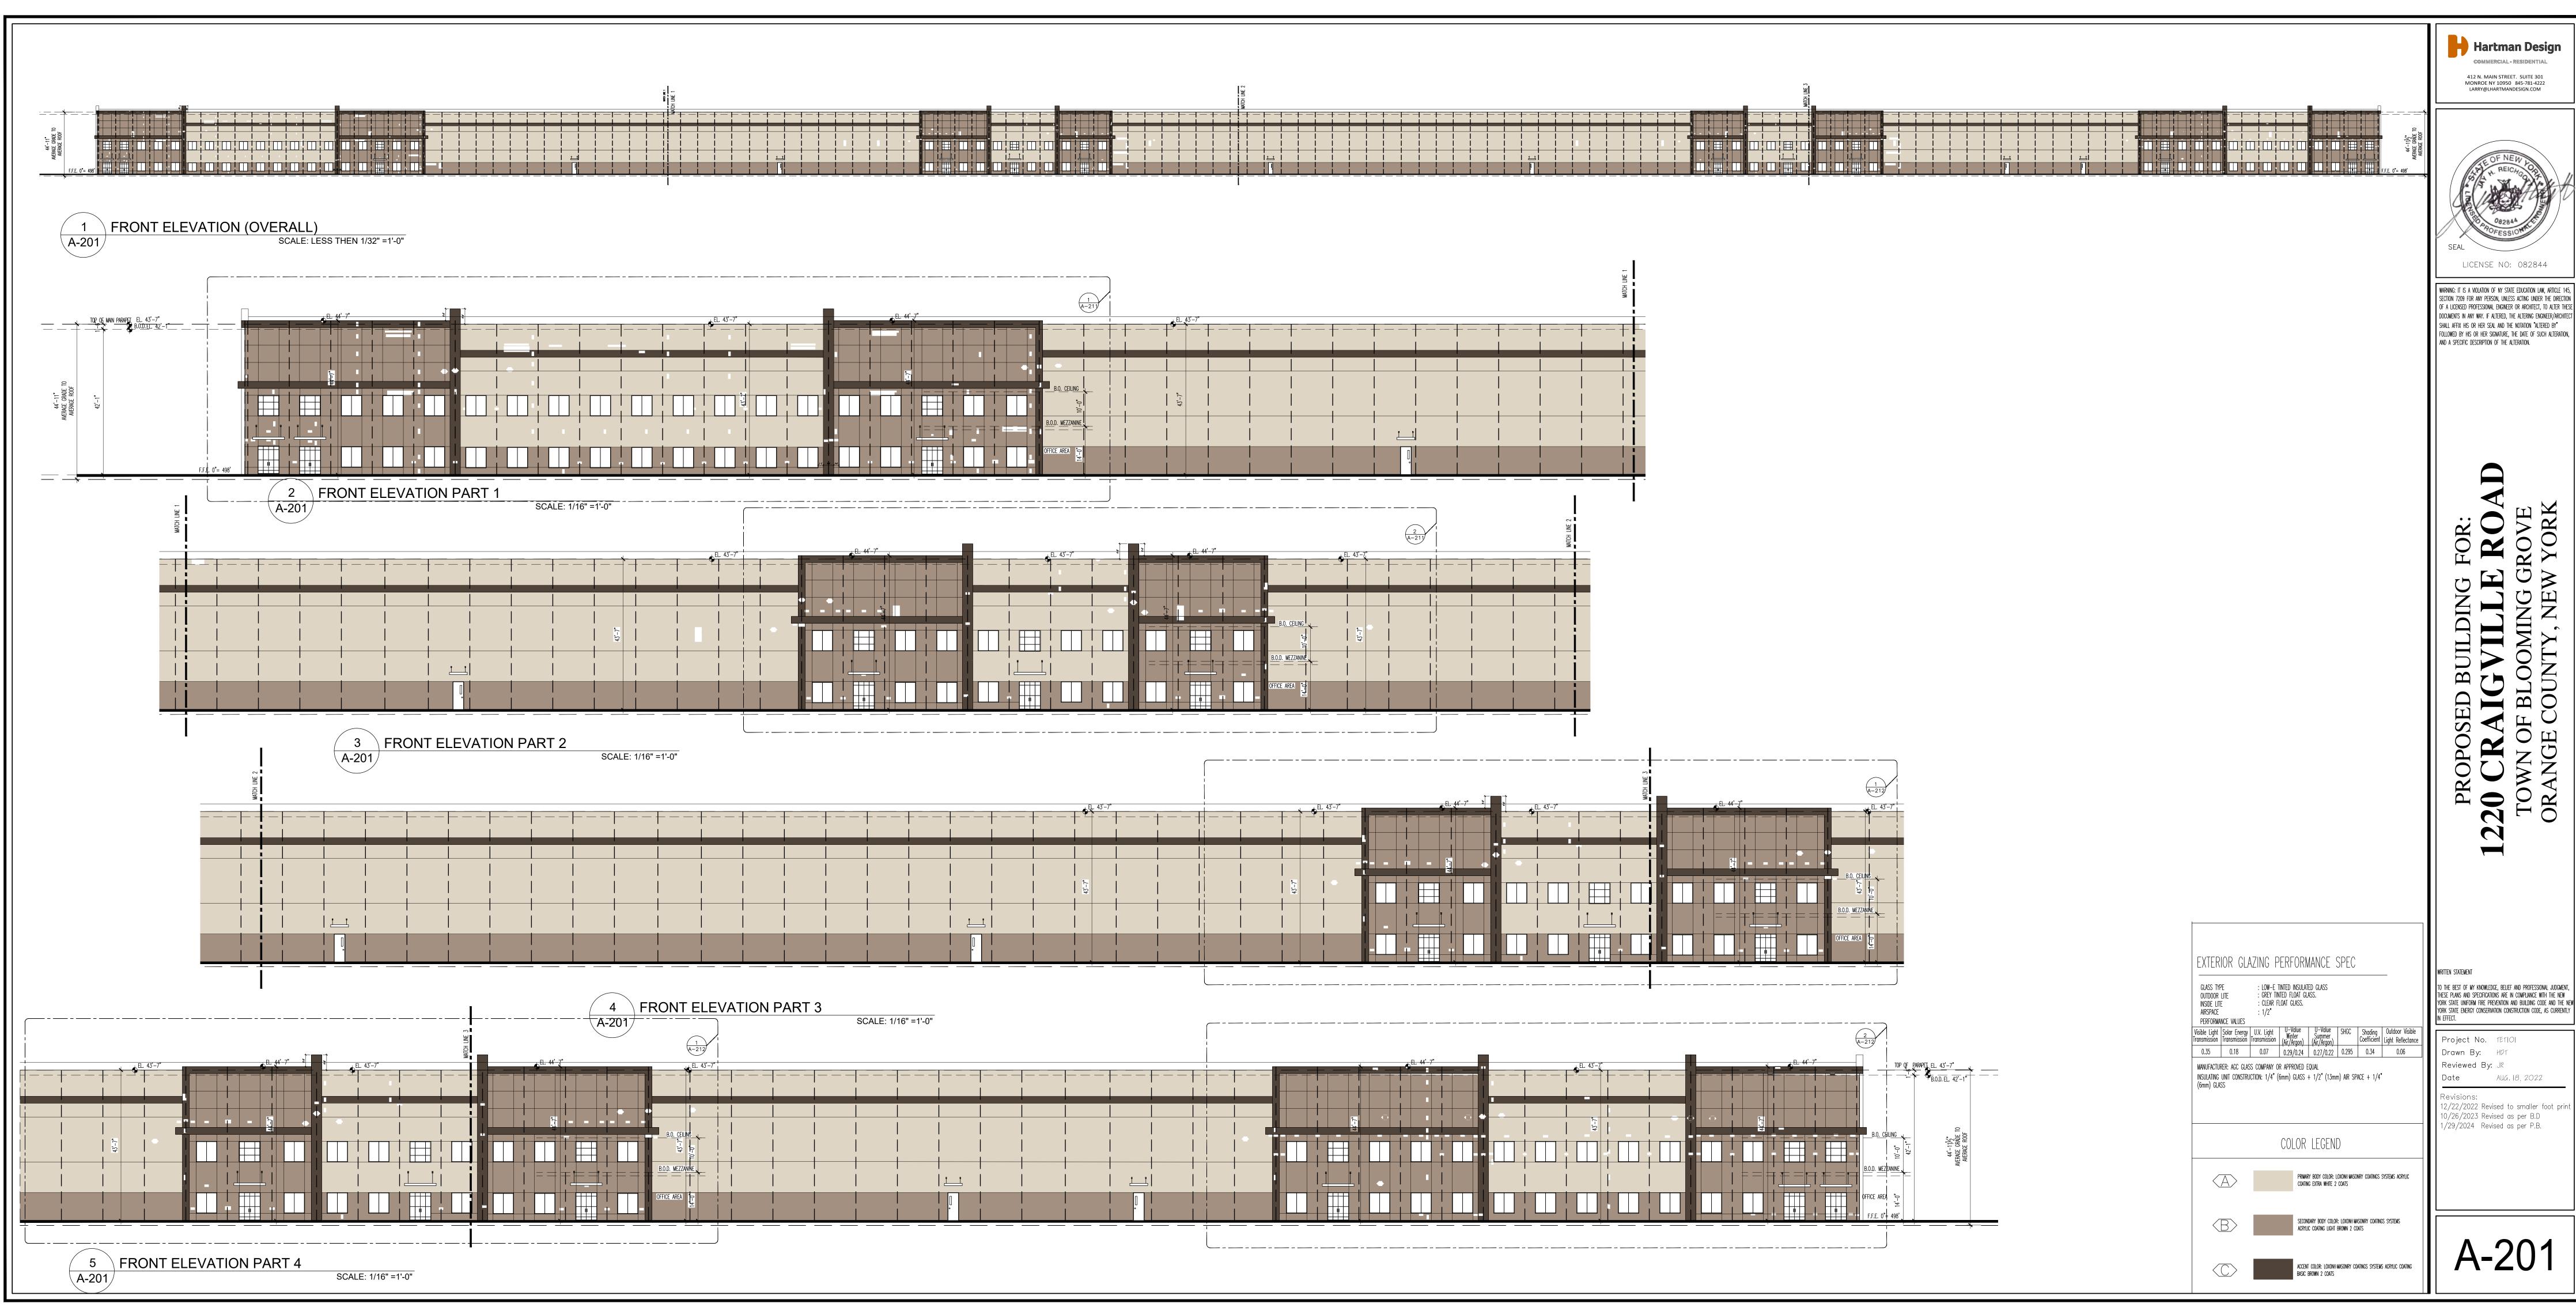



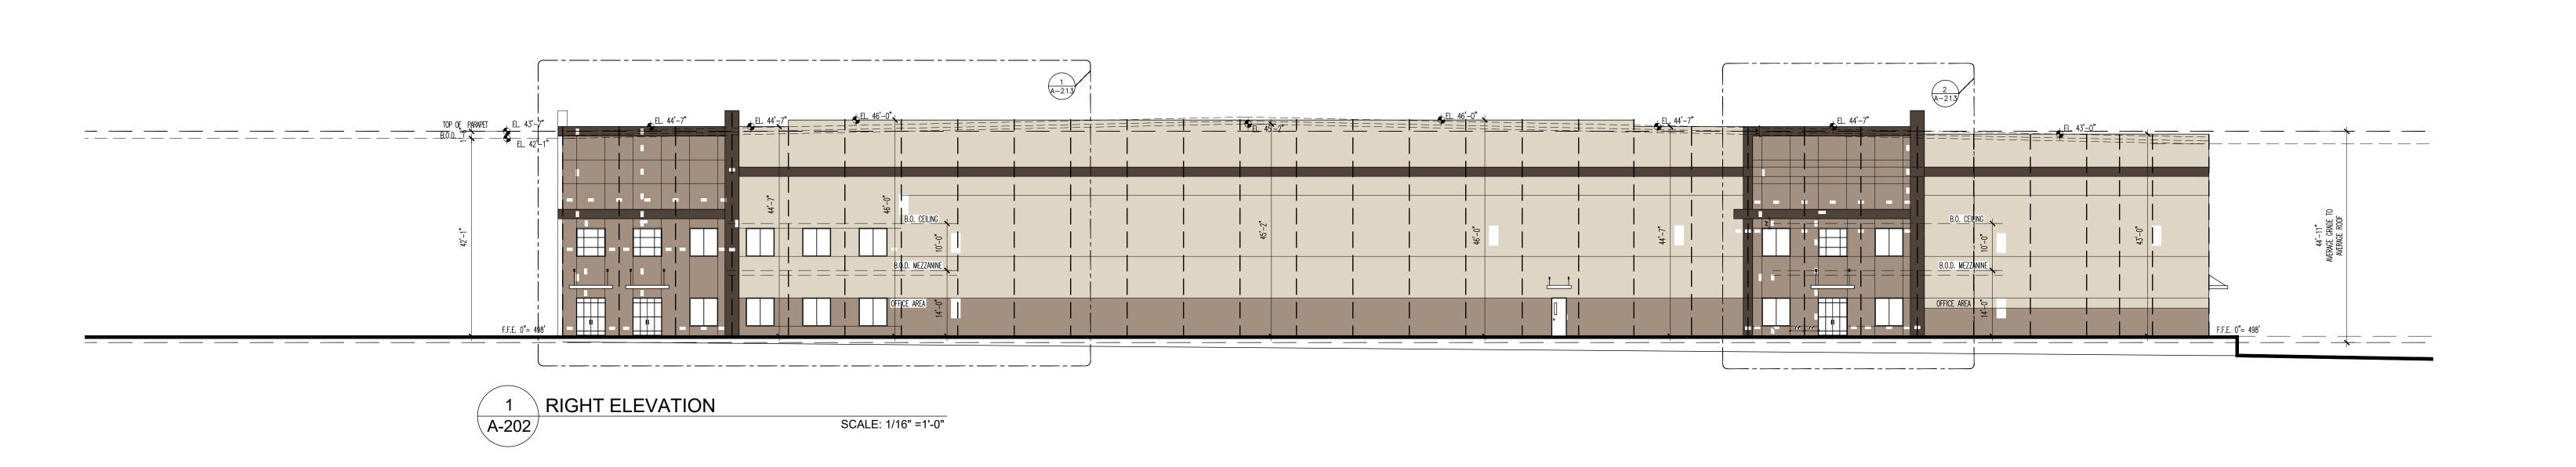

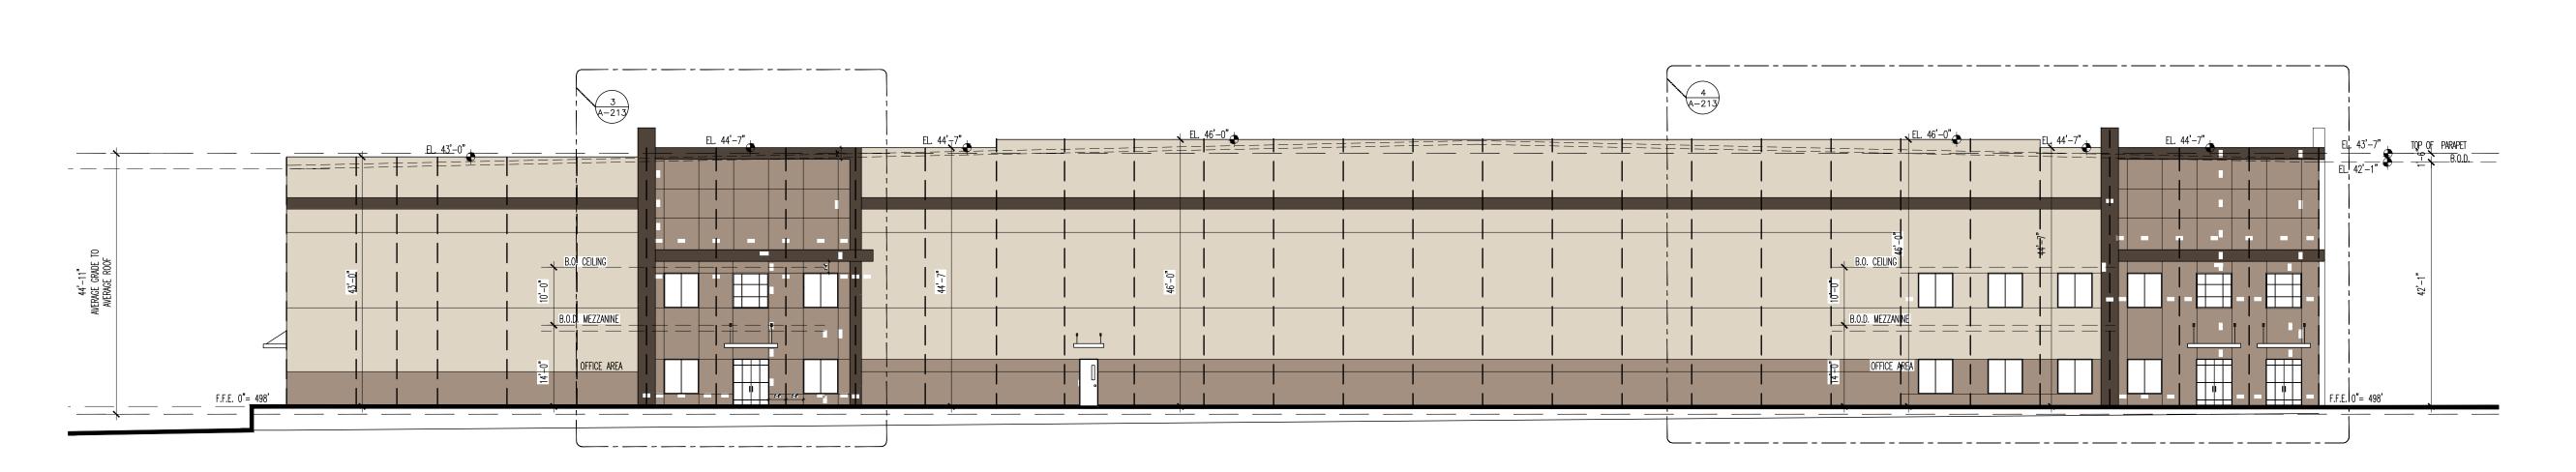







WARNING: IT IS A VIOLATION OF NY STATE EDUCATION LAW, ARTICLE 145, SECTION 7209 FOR ANY PERSON, UNLESS ACTING UNDER THE DIRECTION OF A LICENSED PROFESSIONAL ENGINEER OR ARCHITECT, TO ALTER THESE DOCUMENTS IN ANY WAY. IF ALTERED, THE ALTERING ENGINEER/ARCHITECT SHALL AFFIX HIS OR HER SEAL AND THE NOTATION "ALTERED BY" FOLLOWED BY HIS OR HER SIGNATURE, THE DATE OF SUCH ALTERATION, AND A SPECIFIC DESCRIPTION OF THE ALTERATION.

EXTERIOR GLAZING PERFORMANCE SPEC

MANUFACTURER: AGC GLASS COMPANY OR APPROVED EQUAL

: LOW-E TINTED INSULATED GLASS : GREY TINTED FLOAT GLASS. : CLEAR FLOAT GLASS.

INSULATING UNIT CONSTRUCTION: 1/4" (6mm) GLASS + 1/2" (13mm) AIR SPACE + 1/4" (6mm) GLASS

Visible Light Transmission Transmission U.V. Light Winter (Air/Argon) U.V. Light Winter (Air/Argon) U.V. Light U.V. Light Vinter (Air/Argon) U.V. Ligh

COLOR LEGEND

PRIMARY BODY COLOR: LOXON® MASONRY COATINGS SYSTEMS ACRYLIC COATING EXTRA WHITE 2 COATS

SECONDARY BODY COLOR: LOXON® MASONRY COATINGS SYSTEMS ACRYLIC COATING LIGHT BROWN 2 COATS

GLASS TYPE OUTDOOR LITE INSIDE LITE AIRSPACE

PERFORMANCE VALUES

WRITTEN STATEMENT TO THE BEST OF MY KNOWLEDGE, BELIEF AND PROFESSIONAL JUDGMENT, THESE PLANS AND SPECIFICATIONS ARE IN COMPLIANCE WITH THE NEW YORK STATE UNIFORM FIRE PREVENTION AND BUILDING CODE AND THE NEW YORK STATE ENERGY CONSERVATION CONSTRUCTION CODE, AS CURRENTLY

Project No. 181101 Drawn By: HDT

Reviewed By: JR Date AUG. 18, 2022

12/22/2022 Revised to smaller foot print 10/26/2023 Revised as per B.D

1/29/2024 Revised as per P.B.

ACCENT COLOR: LOXON® MASONRY COATINGS SYSTEMS ACRYLIC COATING BASIC BROWN 2 COATS






LICENSE NO: 082844

WARNING: IT IS A VIOLATION OF NY STATE EDUCATION LAW, ARTICLE 145, SECTION 7209 FOR ANY PERSON, UNLESS ACTING UNDER THE DIRECTION OF A LICENSED PROFESSIONAL ENGINEER OR ARCHITECT, TO ALTER THESE DOCUMENTS IN ANY WAY. IF ALTERED, THE ALTERING ENGINEER/ARCHITECT SHALL AFFIX HIS OR HER SEAL AND THE NOTATION "ALTERED BY" FOLLOWED BY HIS OR HER SIGNATURE, THE DATE OF SUCH ALTERATION, AND A SPECIFIC DESCRIPTION OF THE ALTERATION.

TO THE BEST OF MY KNOWLEDGE, BELIEF AND PROFESSIONAL JUDGMENT, THESE PLANS AND SPECIFICATIONS ARE IN COMPLIANCE WITH THE NEW YORK STATE UNIFORM FIRE PREVENTION AND BUILDING CODE AND THE NEW YORK STATE ENERGY CONSERVATION CONSTRUCTION CODE, AS CURRENTLY

Drawn By: HDT

Reviewed By: JR Date AUG. 18, 2022

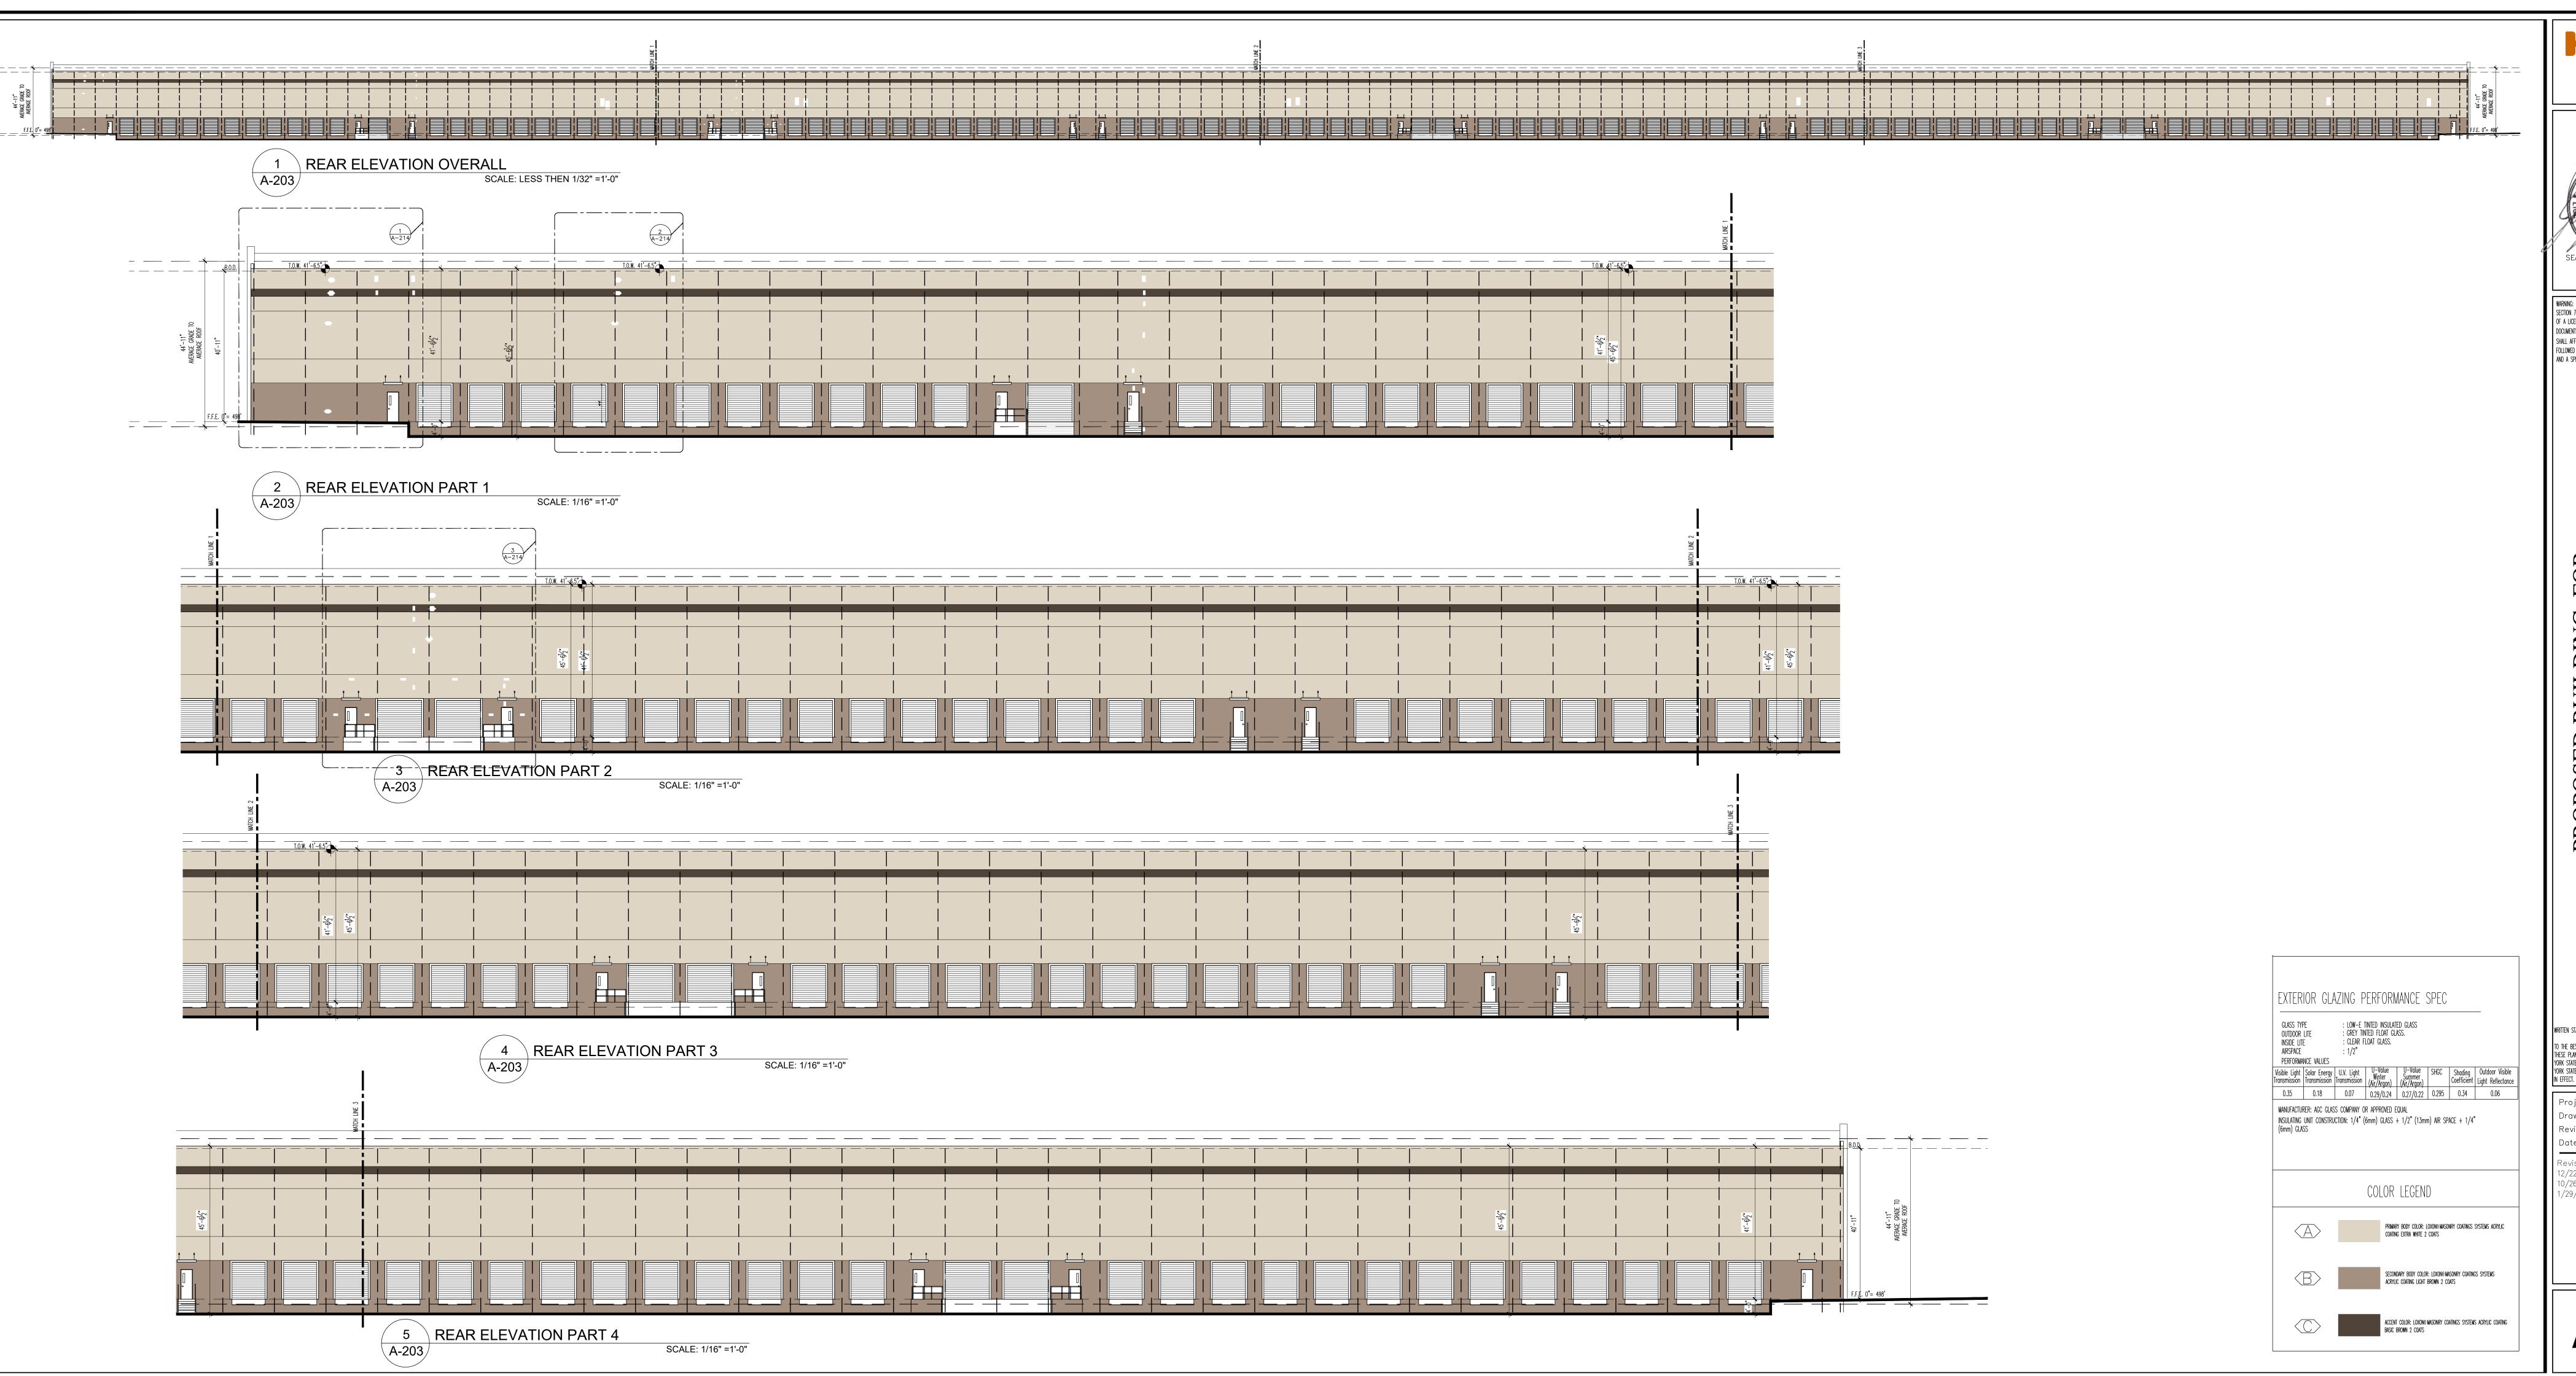



LICENSE NO: 082844

WARNING: IT IS A VIOLATION OF NY STATE EDUCATION LAW, ARTICLE 145, SECTION 7209 FOR ANY PERSON, UNLESS ACTING UNDER THE DIRECTION OF A LICENSED PROFESSIONAL ENGINEER OR ARCHITECT, TO ALTER THESE DOCUMENTS IN ANY WAY. IF ALTERED, THE ALTERING ENGINEER/ARCHITECT SHALL AFFIX HIS OR HER SEAL AND THE NOTATION "ALTERED BY" FOLLOWED BY HIS OR HER SIGNATURE, THE DATE OF SUCH ALTERATION, AND A SPECIFIC DESCRIPTION OF THE ALTERATION.

TO THE BEST OF MY KNOWLEDGE, BELIEF AND PROFESSIONAL JUDGMENT, THESE PLANS AND SPECIFICATIONS ARE IN COMPLIANCE WITH THE NEW YORK STATE UNIFORM FIRE PREVENTION AND BUILDING CODE AND THE NEW YORK STATE ENERGY CONSERVATION CONSTRUCTION CODE, AS CURRENTLY

Project No. 181101

Drawn By: HD1 Reviewed By: JR Date AUG. 18, 2022



412 N. MAIN STREET. SUITE 301 MONROE NY 10950 845-781-4222 LARRY@LHARTMANDESIGN.COM



VARNING: IT IS A VIOLATION OF NY STATE EDUCATION LAW, ARTICLE 145, FOLLOWED BY HIS OR HER SIGNATURE, THE DATE OF SUCH ALTERATION,

TO THE BEST OF MY KNOWLEDGE, BELIEF AND PROFESSIONAL JUDGMENT, THESE PLANS AND SPECIFICATIONS ARE IN COMPLIANCE WITH THE NEW YORK STATE UNIFORM FIRE PREVENTION AND BUILDING CODE AND THE NEW YORK STATE ENERGY CONSERVATION CONSTRUCTION CODE, AS CURRENTLY

Reviewed By: JR

Date AUG. 18, 2022



Hartman Design

COMMERCIAL • RESIDENTIAL

412 N. MAIN STREET. SUITE 301

MONROE NY 10950 845-781-4222

LARRY@LHARTMANDESIGN.COM



CENSE NO: 082844

WARNING: IT IS A VIOLATION OF NY STATE EDUCATION LAW, ARTICLE 145, SECTION 7209 FOR ANY PERSON, UNLESS ACTING UNDER THE DIRECTION OF A LICENSED PROFESSIONAL ENGINEER OR ARCHITECT, TO ALTER THESE DOCUMENTS IN ANY WAY. IF ALTERED, THE ALTERING ENGINEER/ARCHITECT SHALL AFFIX HIS OR HER SEAL AND THE NOTATION "ALTERED BY" FOLLOWED BY HIS OR HER SIGNATURE, THE DATE OF SUCH ALTERATION, AND A SPECIFIC DESCRIPTION OF THE ALTERATION.

FOLLOWED BY HIS OR HER SIGNATURE, THE DATE OF SUCH ALTERATION.

AND A SPECIFIC DESCRIPTION OF THE ALTERATION.

PROPOSED BUILDING FOR:

O CRAIGVILLE ROA

TOWN OF BLOOMING GROVE
RANGE COUNTY, NEW YORK

EN STATEMENT

TO THE BEST OF MY KNOWLEDGE, BELIEF AND PROFESSIONAL JUDGMENT,
THESE PLANS AND SPECIFICATIONS ARE IN COMPLIANCE WITH THE NEW
YORK STATE UNIFORM FIRE PREVENTION AND BUILDING CODE AND THE NEW
YORK STATE ENERGY CONSERVATION CONSTRUCTION CODE, AS CURRENTLY

Project No. 1810

Drawn By: HDT

Reviewed By: JR

Date AUG. 18, 2022

Date AUG. 18, 2022

Revisions:
12/22/2022 Revised to smaller foot print 10/26/2023 Revised as per B.D.

12/22/2022 Revised to smaller foot print 10/26/2023 Revised as per B.D 1/29/2024 Revised as per P.B.

Λ 212



Hartman Design COMMERCIAL - RESIDENTIAL 412 N. MAIN STREET. SUITE 301 MONROE NY 10950 845-781-4222 LARRY@LHARTMANDESIGN.COM



LICENSE NO: 082844


WARNING: IT IS A VIOLATION OF NY STATE EDUCATION LAW, ARTICLE 145, SECTION 7209 FOR ANY PERSON, UNLESS ACTING UNDER THE DIRECTION OF A LICENSED PROFESSIONAL ENGINEER OR ARCHITECT, TO ALTER THESE DOCUMENTS IN ANY WAY. IF ALTERED, THE ALTERING ENGINEER/ARCHITECT SHALL AFFIX HIS OR HER SEAL AND THE NOTATION "ALTERED BY"


FOLLOWED BY HIS OR HER SIGNATURE, THE DATE OF SUCH ALTERATION, AND A SPECIFIC DESCRIPTION OF THE ALTERATION.

TO THE BEST OF MY KNOWLEDGE, BELIEF AND PROFESSIONAL JUDGMENT, THESE PLANS AND SPECIFICATIONS ARE IN COMPLIANCE WITH THE NEW YORK STATE UNIFORM FIRE PREVENTION AND BUILDING CODE AND THE NEW YORK STATE ENERGY CONSERVATION CONSTRUCTION CODE, AS CURRENTLY

Reviewed By: JR

Date AUG. 18, 2022

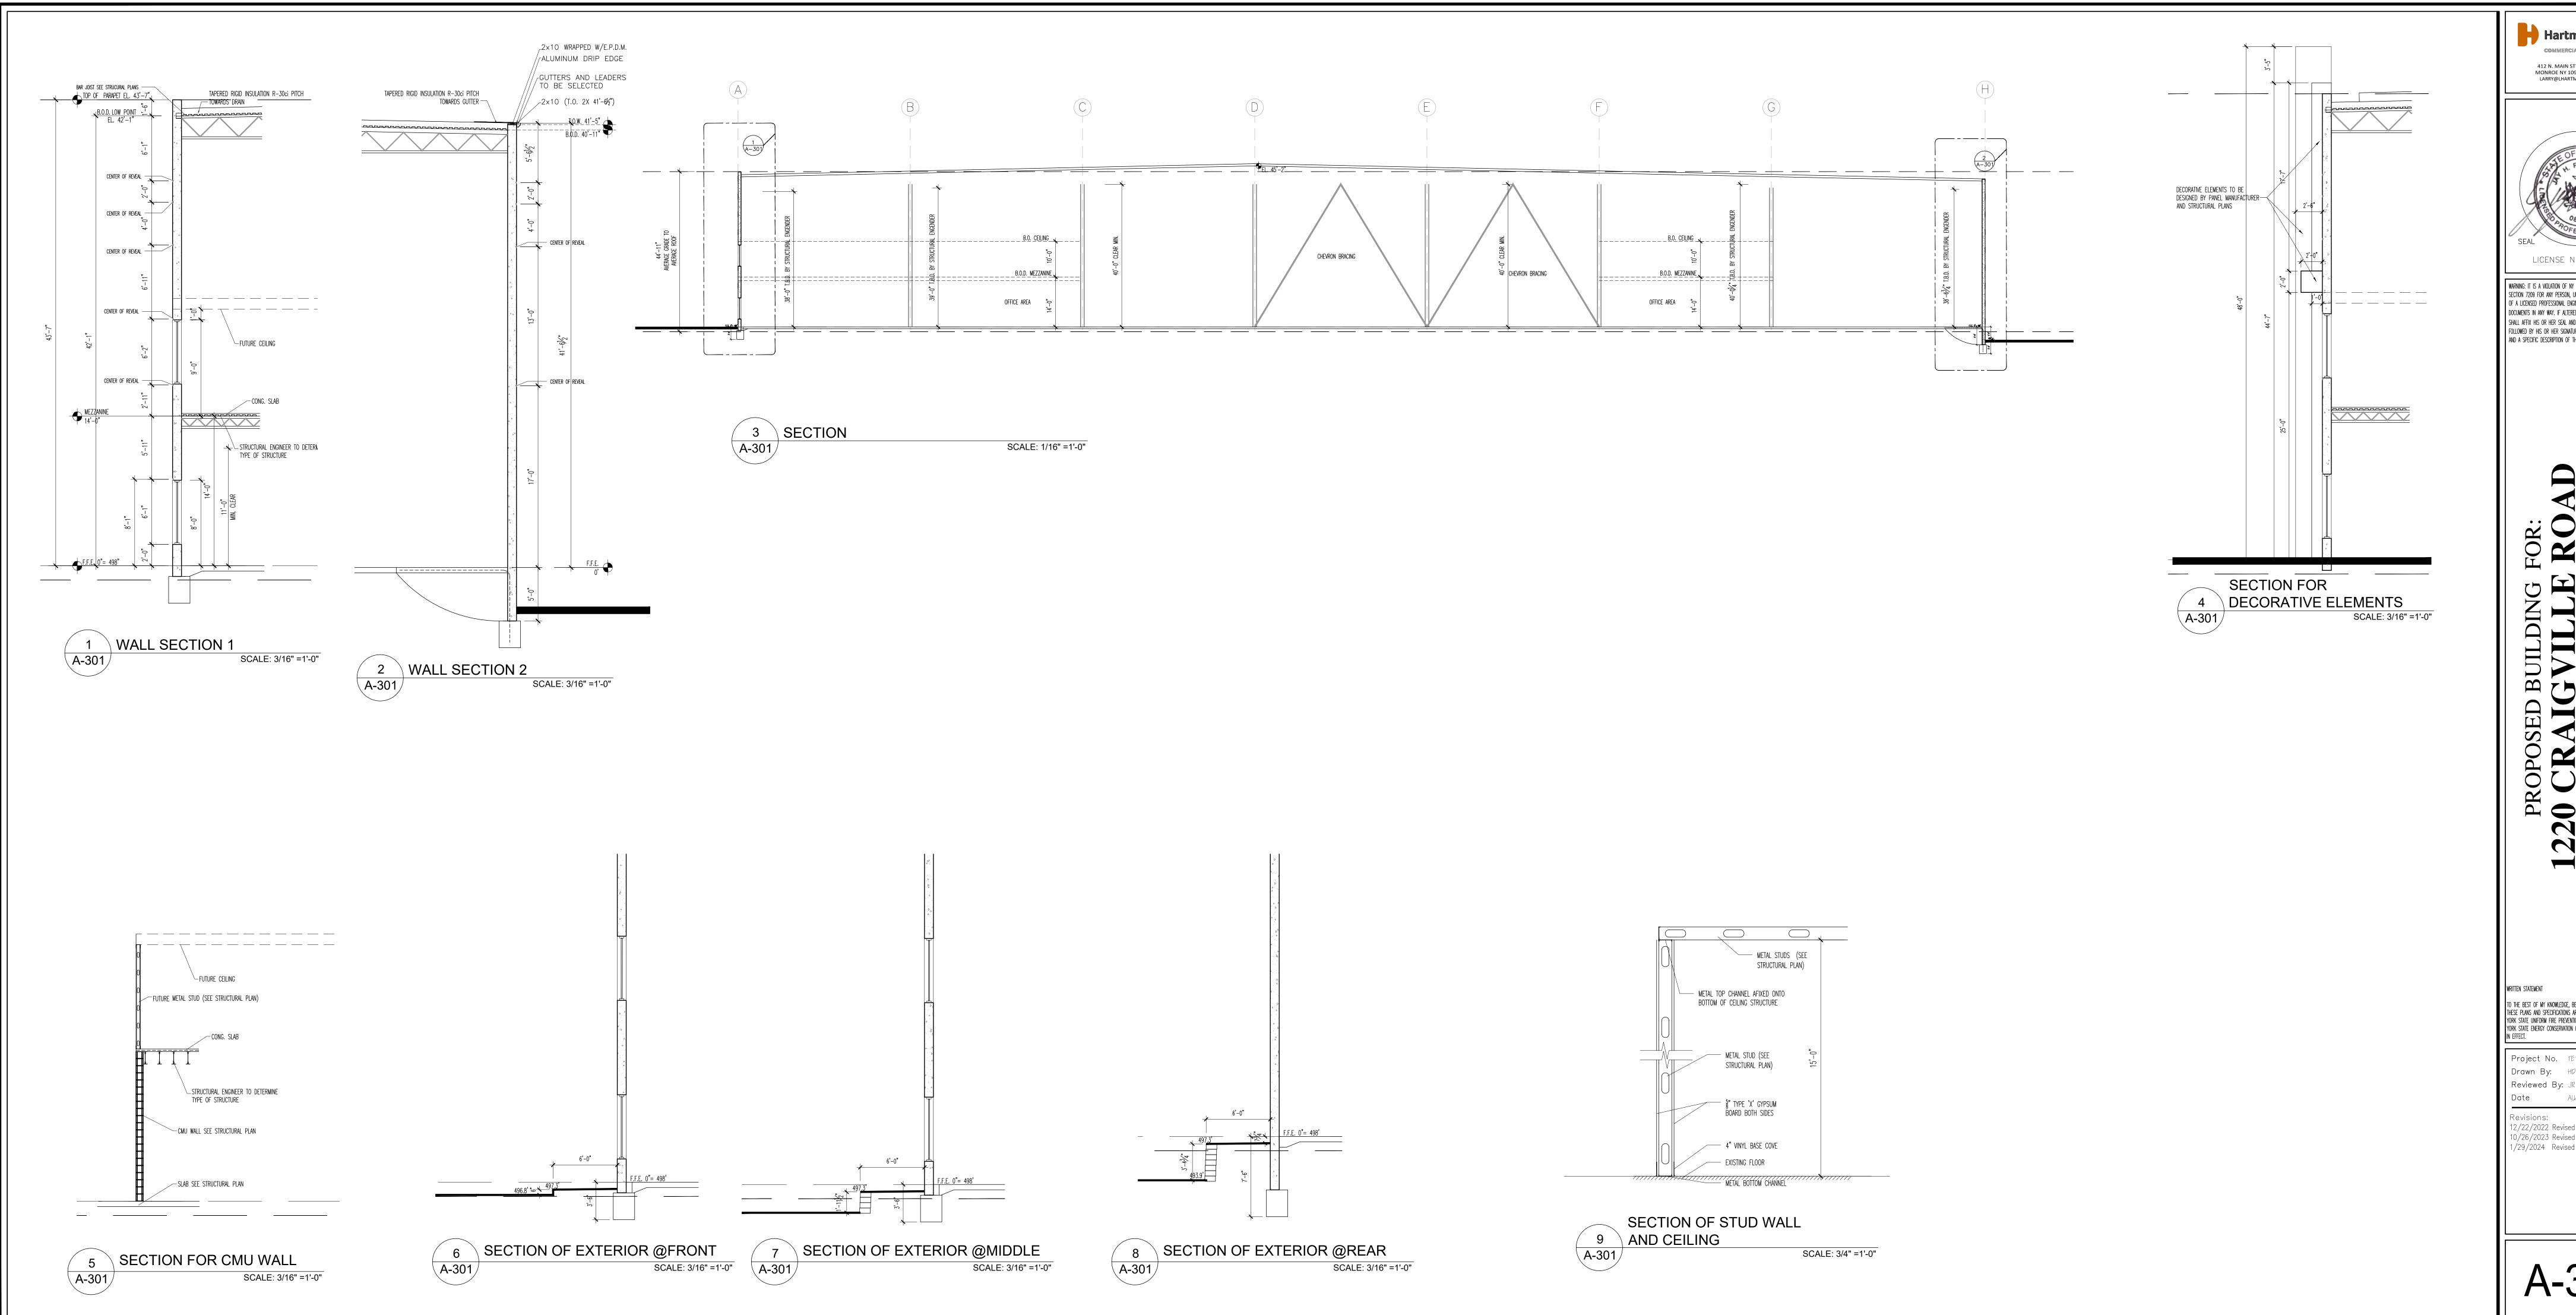

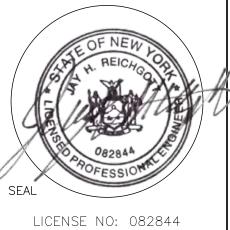


Warning: It is a violation of NY State Education Law, article 145, section 7209 for any person, unless acting under the direction

OF A LICENSED PROFESSIONAL ENGINEER OR ARCHITECT, TO ALTER THESE DOCUMENTS IN ANY WAY. IF ALTERED, THE ALTERING ENGINEER/ARCHITECT SHALL AFFIX HIS OR HER SEAL AND THE NOTATION "ALTERED BY"
FOLLOWED BY HIS OR HER SIGNATURE, THE DATE OF SUCH ALTERATION,
AND A SPECIFIC DESCRIPTION OF THE ALTERATION.


TO THE BEST OF MY KNOWLEDGE, BELIEF AND PROFESSIONAL JUDGMENT, THESE PLANS AND SPECIFICATIONS ARE IN COMPLIANCE WITH THE NEW YORK STATE UNIFORM FIRE PREVENTION AND BUILDING CODE AND THE NEW YORK STATE ENERGY CONSERVATION CONSTRUCTION CODE, AS CURRENTLY


Project No. 181101 Drawn By: HDT Reviewed By: JR

Date AUG. 18, 2022

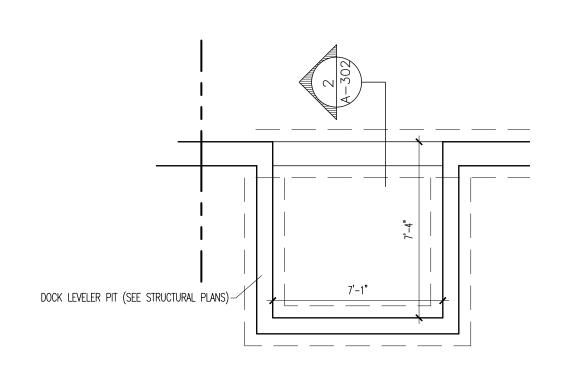




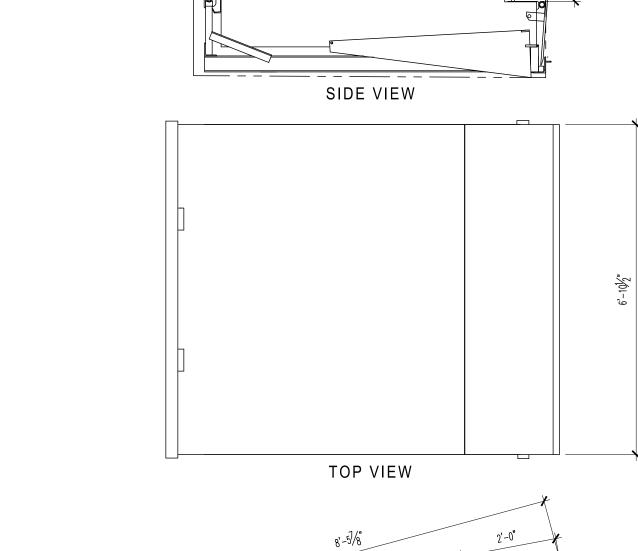


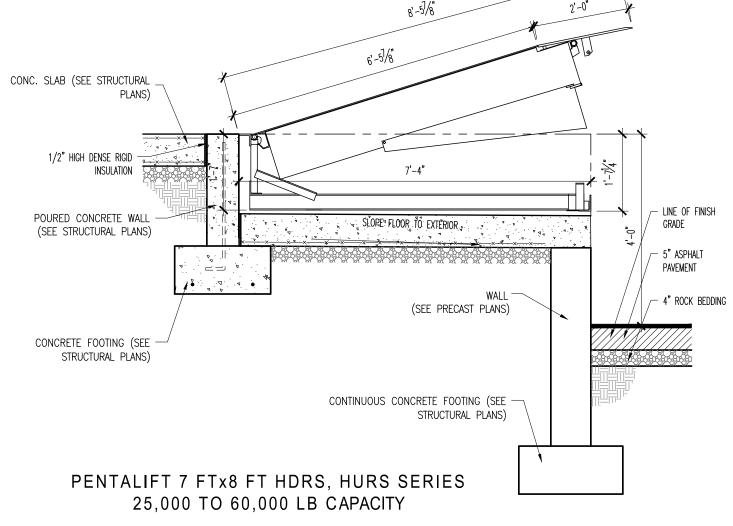

HYDRAULIC DOCK LEVELER DETAIL

SCALE: 1/2" =1'-0"

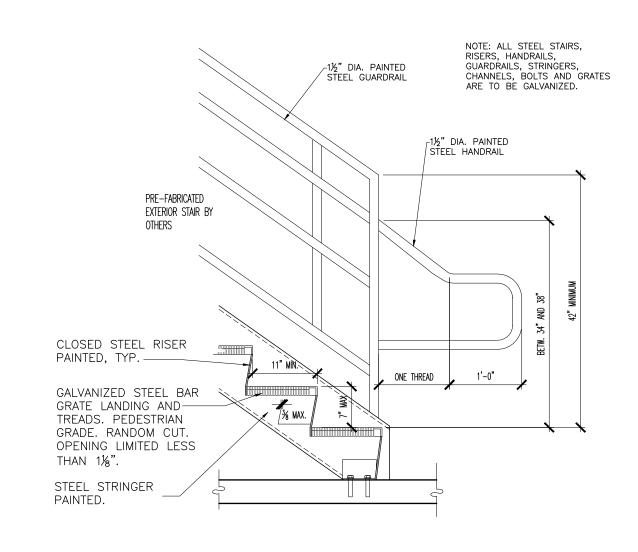


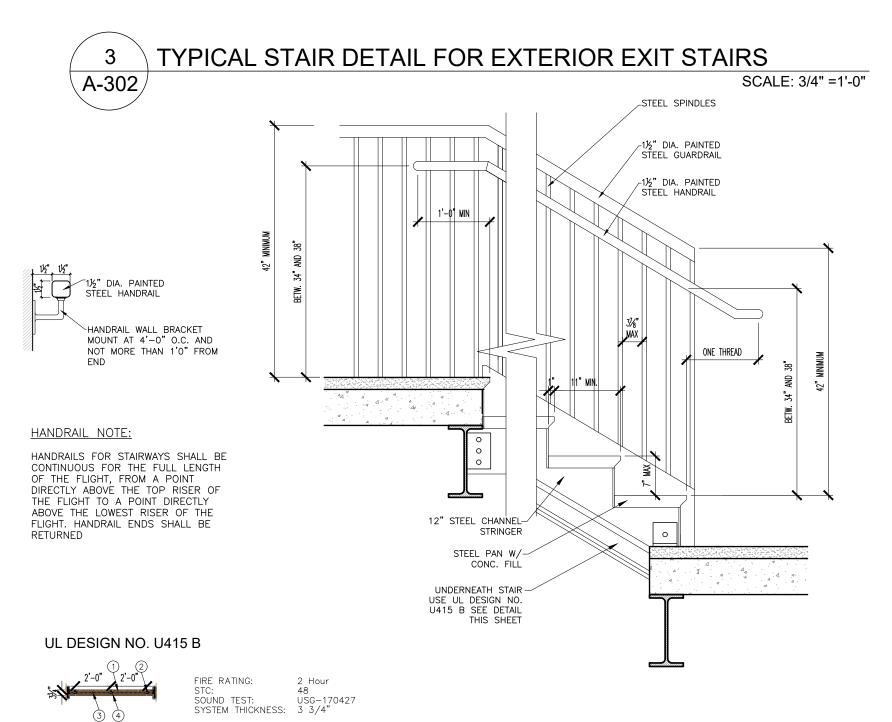


TYPICAL STAIR DETAIL FOR ALL INTERIOR STAIRS

ASSEMBLY OPTIONS:

ONE LAYER 1" THICK GYPSUM LINER PANEL (UL TYPE SLX™)
 2-1/2" CH STUDS, 20 GA. MSG., SPACED 24" O.C.
 1-1/2" GLASS FIBER BATT INSULATION IN CAVITY
 TWO LAYERS 5/8" THICK GYPSUM BOARD (UL TYPE SCX™)

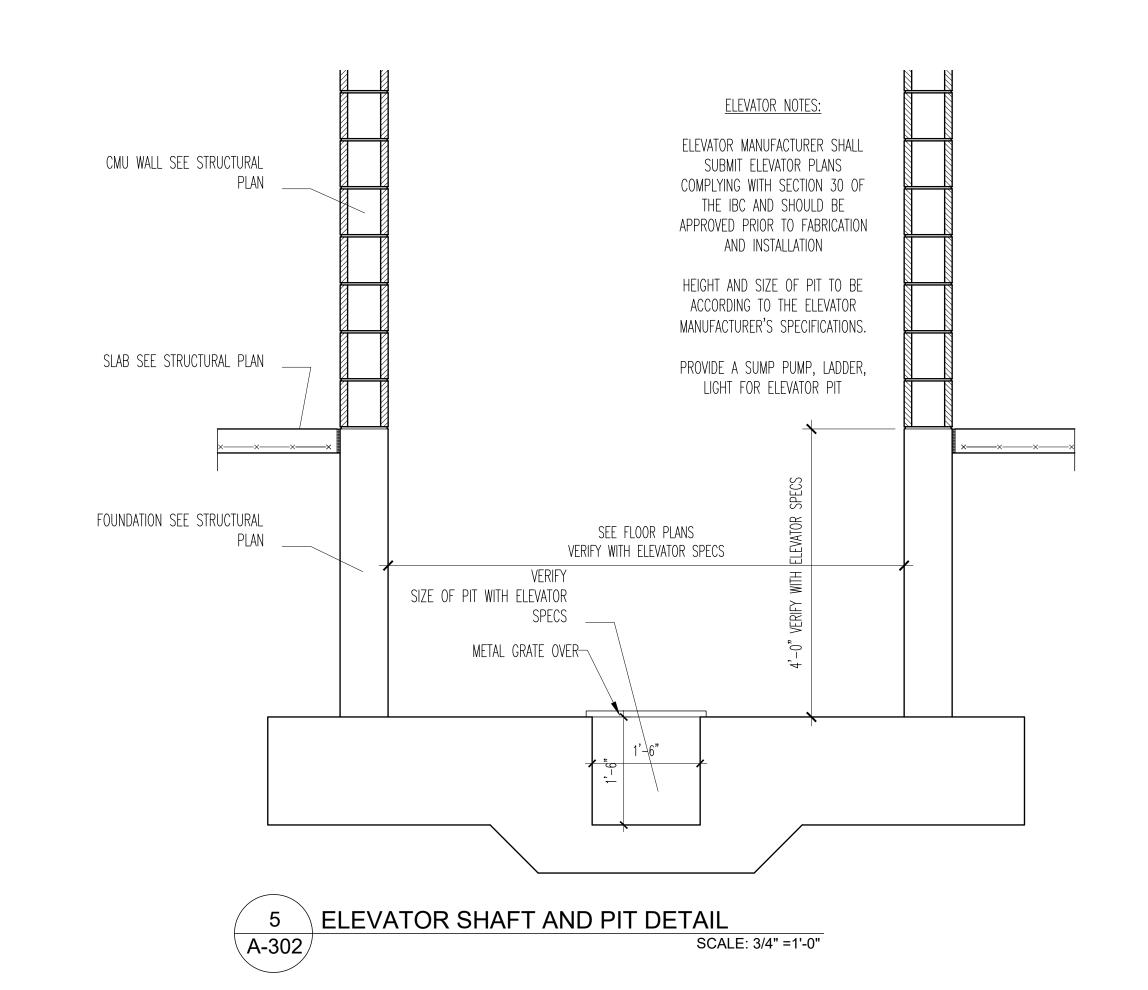

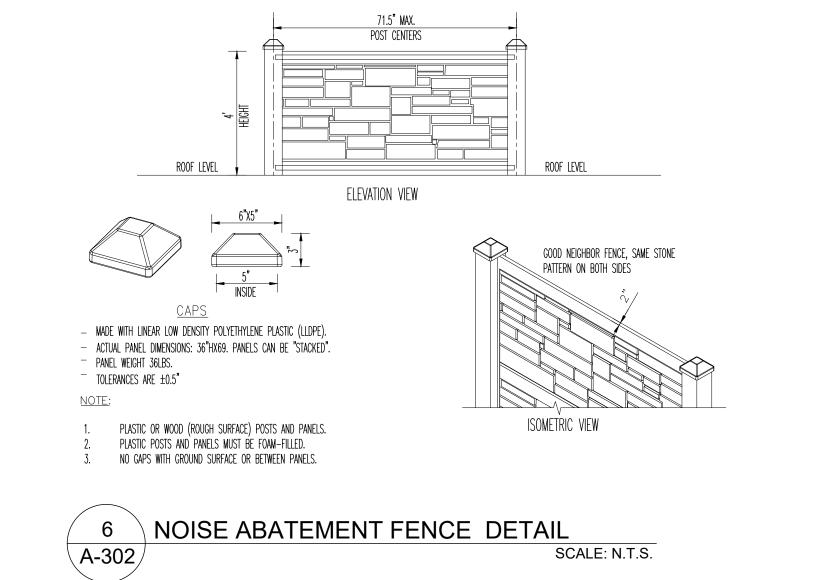


ALL WORK AS WELL AS THE USE OF THE BUILDING TO COMPLY

BUILDING TO BE EQUIPPED WITH A SMOKE AND FIRE ALARM SYSTEM. A FIRE ALARM PLAN OF NEW ADDITION AS WELL AS THE PLAN OF THE EXISTING FIRE ALARM IN THE EXISTING BUILDING SHOULD BE SUBMITTED TO THE BUILDING DEPARTMENT AND APPROVED PRIOR OF INSTILLATION

CONTRACTOR SHALL HIRE A THIRD PARTY TO DO THE SPECIAL INSPECTIONS AS SPECIFIED IN CHAPTER 17 OF THE NYS BUILDING CODE. INSPECTIONS SHALL INCLUDE BUT NOT BE LIMITED TO SOILS, REINFORCED CONCRETE, EXCAVATION AND FILLING, HIGH-STRENGTH BOLTING & STEEL FRAME INSPECTION, AND STEEL

SOIL BEARING CAPACITY IS 4000 PSF. CONTRACTOR TO SUBMIT SOIL TEST REPORT PRIOR OF POURING OF ANY CONCRETE

- ALL EXIT DOOR HARDWARE TO COMPLY WITH SECTION 1008 OF NYS BUILDING CODE
- THE ACTUATING PORTION OF THE RELEASING DEVICE SHALL EXTEND AT LEAST ONE—HALF OF THE DOOR LEAF WIDTH
- EXCEED 15 POUNDS (67 N).
- HARDWARE DEVICES SHALL BE INSTALLED 34 INCHES (864 MM) MINIMUM AND 48 INCHES (1219

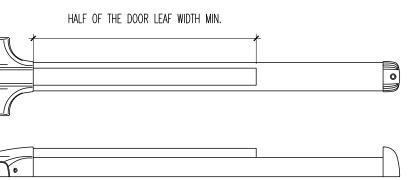

FIRE SAFETY NOTES:

WITH THE LATEST NYS FIRE CODE AND NFPA CODE

BUILDING TO BE EQUIPPED WITH A NFPA 13 AUTOMATED SPRINKLER SYSTEM.

CONTRACTOR TO MAINTAIN AT ALL TIME ALL THE REQUIRED EXITS AND FIRE PROTECTION SYSTEMS OF EXISTING OCCUPIED BUILDING DURING CONSTRUCTION AS SPECIFIED IN CHAPTER 14 OF THE NYS EXISTING BUILDING CODE


SEE EVACUATION PLAN FOR LOCATION OF TWO NEW DOORS IN EXISTING BUILDING TO REPLACE EXIST. FIRE DOOR THAT WILL BE BLOCKED DURING CONSTRUCTION

#### **INSPECTION NOTES:**


THE THIRD PARTY SHALL SUBMIT ALL REPORTS AFTER EACH INSPECTION TO THE LOCAL BUILDING DEPARTMENT

#### PANIC DOOR HARDWARE NOTES:

- THE MAXIMUM UNLATCHING FORCE SHALL NOT
- MM) MAXIMUM ABOVE THE FINISHED FLOOR.

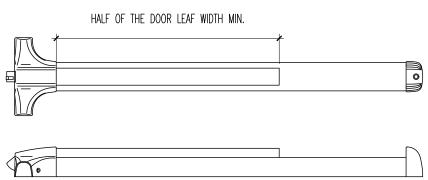

Hartman Design COMMERCIAL - RESIDENTIAL 412 N. MAIN STREET. SUITE 301 MONROE NY 10950 845-781-4222 LARRY@LHARTMANDESIGN.COM

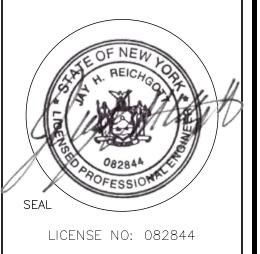

WARNING: IT IS A VIOLATION OF NY STATE EDUCATION LAW, ARTICLE 145, SECTION 7209 FOR ANY PERSON, UNLESS ACTING UNDER THE DIRECTION OF A LICENSED PROFESSIONAL ENGINEER OR ARCHITECT, TO ALTER THES

DOCUMENTS IN ANY WAY. IF ALTERED, THE ALTERING ENGINEER/ARCHITEC SHALL AFFIX HIS OR HER SEAL AND THE NOTATION "ALTERED BY" FOLLOWED BY HIS OR HER SIGNATURE, THE DATE OF SUCH ALTERATION, AND A SPECIFIC DESCRIPTION OF THE ALTERATION.

TO THE BEST OF MY KNOWLEDGE, BELIEF AND PROFESSIONAL JUDGMENT, THESE PLANS AND SPECIFICATIONS ARE IN COMPLIANCE WITH THE NEW YORK STATE UNIFORM FIRE PREVENTION AND BUILDING CODE AND THE NEW YORK STATE ENERGY CONSERVATION CONSTRUCTION CODE, AS CURRENTLY

Project No. 181101 Drawn By: HDT Reviewed By: JR

Date AUG. 18, 2022 2/22/2022 Revised to smaller foot print

10/26/2023 Revised as per B.D 1/29/2024 Revised as per P.B.

Hartman Design COMMERCIAL - RESIDENTIAL 412 N. MAIN STREET. SUITE 301 MONROE NY 10950 845-781-4222 LARRY@LHARTMANDESIGN.COM




WARNING: IT IS A VIOLATION OF NY STATE EDUCATION LAW, ARTICLE 145, SECTION 7209 FOR ANY PERSON, UNLESS ACTING UNDER THE DIRECTION OF A LICENSED PROFESSIONAL ENGINEER OR ARCHITECT, TO ALTER THESE DOCUMENTS IN ANY WAY. IF ALTERED, THE ALTERING ENGINEER/ARCHITECT SHALL AFFIX HIS OR HER SEAL AND THE NOTATION "ALTERED BY" FOLLOWED BY HIS OR HER SIGNATURE, THE DATE OF SUCH ALTERATION, AND A SPECIFIC DESCRIPTION OF THE ALTERATION.


WRITTEN STATEMENT TO THE BEST OF MY KNOWLEDGE, BELIEF AND PROFESSIONAL JUDGMENT, THESE PLANS AND SPECIFICATIONS ARE IN COMPLIANCE WITH THE NEW YORK STATE UNIFORM FIRE PREVENTION AND BUILDING CODE AND THE NEW YORK STATE ENERGY CONSERVATION CONSTRUCTION CODE, AS CURRENTLY

Project No. 181101 Drawn By: HDT Reviewed By: JR

Date AUG. 18, 2022

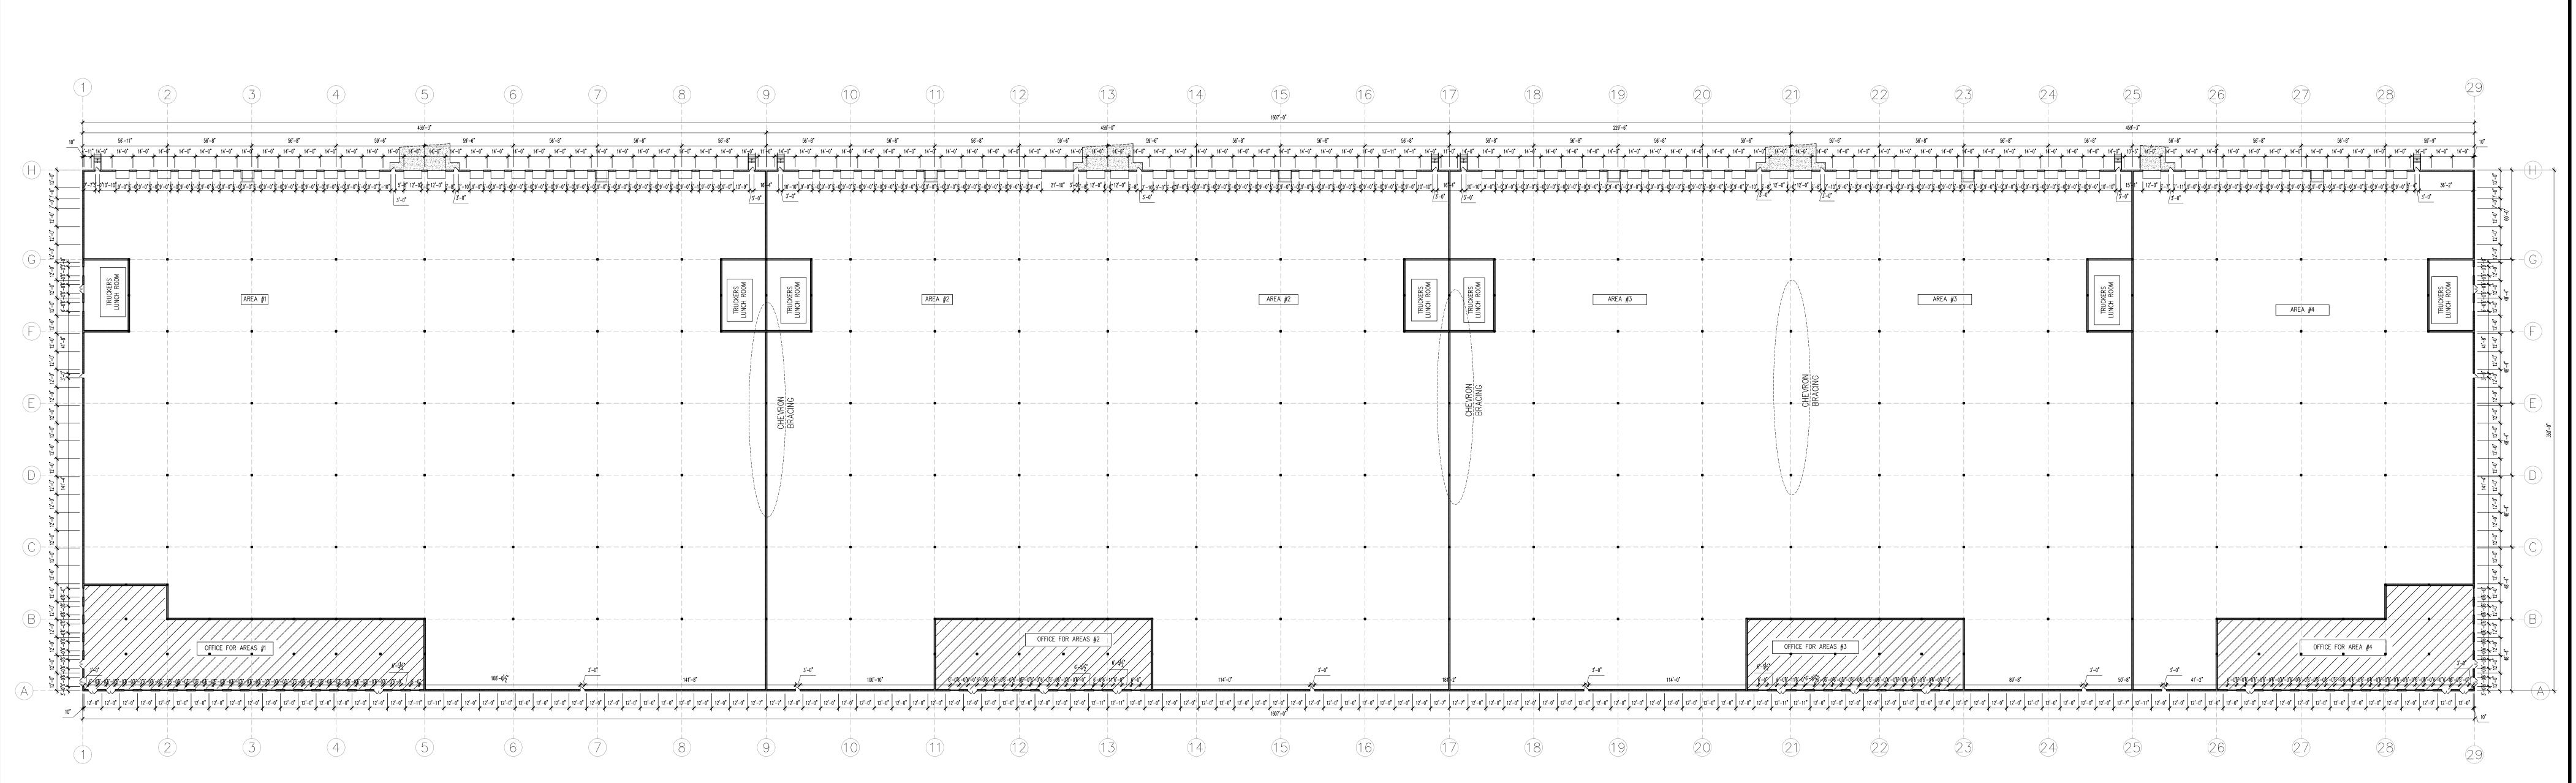

DIMENSION FOR PANELS SCALE: LESS THEN 1/32" =1'-0" 412 N. MAIN STREET. SUITE 301 MONROE NY 10950 845-781-4222 LARRY@LHARTMANDESIGN.COM

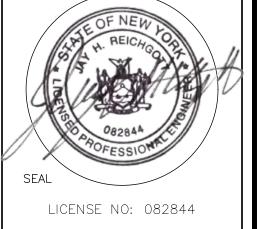

WARNING: IT IS A VIOLATION OF NY STATE EDUCATION LAW, ARTICLE 145, SECTION 7209 FOR ANY PERSON, UNLESS ACTING UNDER THE DIRECTION OF A LICENSED PROFESSIONAL ENGINEER OR ARCHITECT, TO ALTER THES DOCUMENTS IN ANY WAY. IF ALTERED, THE ALTERING ENGINEER/ARCHITEC SHALL AFFIX HIS OR HER SEAL AND THE NOTATION "ALTERED BY" FOLLOWED BY HIS OR HER SIGNATURE, THE DATE OF SUCH ALTERATION, AND A SPECIFIC DESCRIPTION OF THE ALTERATION.

WRITTEN STATEMENT TO THE BEST OF MY KNOWLEDGE, BELIEF AND PROFESSIONAL JUDGMENT, THESE PLANS AND SPECIFICATIONS ARE IN COMPLIANCE WITH THE NEW YORK STATE UNIFORM FIRE PREVENTION AND BUILDING CODE AND THE NEW YORK STATE ENERGY CONSERVATION CONSTRUCTION CODE, AS CURRENTLY

Project No. 181101 Drawn By: HD1 Reviewed By: JR

Date AUG. 18, 2022 12/22/2022 Revised to smaller foot print 10/26/2023 Revised as per B.D

1/29/2024 Revised as per P.B.